JOINT PUBLIC NOTICE

August 22, 2013

DEPARTMENT OF THE ARMY **NEW ORLEANS DISTRICT** CORPS OF ENGINEERS REGULATORY FUNCTIONS BRANCH P.O. BOX 60267 NEW ORLEANS, LA 70160

STATE OF LOUISIANA DEPARTMENT OF ENVIRONMENTAL QUALITY OFFICE OF ENVIRONMENTAL **SERVICES** P.O. BOX 4313 BATON ROUGE, LA 70821-4313

STATE OF LOUISIANA DEPARTMENT OF NATURAL **RESOURCES** OFFICE OF COASTAL MANAGEMENT P.O. BOX 44487 BATON ROUGE, LA 70804-4487

Phone (504) 862-1217

(504) 862-2574

Email Kenneth.G.Blanke@usace.army.mil

Phone (225) 219-3225

(225) 325-8250

Phone (225) 342-3781 (225) 342-9439 Fax

Email vickie.amedee@la.gov

COE REVIEWER:

DEQ REVIEWER: Kenny Blanke Jamie Phillippe

OCM REVIEWER: Vickie Amedee

COE NUMBER:

MVN-2013-1561-CQ

WQC NUMBER:

130814-01

CUP NUMBER:

P20130675

NAME:

COASTAL PROTECTION AND RESTORATION AUTHORITY

c/o URS CORPORATION

3500 N. CAUSEWAY BLVD., SUITE 900

METAIRIE, LA 70002 Attn: Jim Leblanc

LOCATION:

Ascension, Saint James, Saint John The Baptist Parishes, LA; Channel P.O.B. @ Lat. 30° 03' 03.36"N, Long.

90° 38' 36.52"W; Channel P.O.E. @ Lat. 30° 07' 21.49"N, Long. 90° 38' 26.11"W; Garyville, LA

DESCRIPTION: Proposed River Reintroduction into Maurepas Swamp (PO-29). An intake channel will be excavated in the Mississippi River batture, a gated structure will be built through the levee, and three 10' x 10' box culverts will be installed to convey river water under the levee and River Road. The culverts will discharge into a large sand settling basin, connected to a 5.5 mile long banked conveyance channel, which will divert flow to the Maurepas Swamp. Four 8' x 8' box culverts will be installed to cross under the Canadian National Railway, a bridge will be constructed over the Kansas City Southern Railway and six 9' x 9' box culverts will be installed to cross under US Hwy. 61. Just north of US Hwy. 61, the channel will follow the existing Hope Canal alignment to ultimately distribute the diverted water into the wetlands 1,000' north of I-10. A drainage pumping station will be constructed at the confluence of the Hope and Bourgeois Canals to maintain the existing storm water drainage capacity in the vicinity of the community of Garyville. The existing Hope Canal boat launch and dock will be relocated immediately north of the new pump station. Rock weirs will be installed at Blind River, Bourgeois Canal and Bayou Secret. Five cuts will be created in the abandoned railroad embankment north of I-10 and east of Blind River. Ten check valves will be installed on the north side of I-10 on the existing culverts under the interstate. Approx. 1,021,236 cu. yds. of native material will be excavated and disposed of off-site, 443,579 cu. yds. of topsoil/dirt, 85,340 cu. yds. of soil/cement mixing, 10,344 cu. yds. of crushed stone/gravel, 4,400 cu. yds. of rock and 700 cu. yds. of concrete will be required for project activities. Approx. 140 acres of wetland habitat, 71 acres of non-wetland habitat and 20 acres of non-vegetated waterbottoms may be impacted as a result of this proposed activity.

NOTICE the Louisiana Department of Natural Resources, Office of Coastal Management (OCM) has received the above application for a Coastal Use Permit (CUP) in accordance with the State and Local Coastal Resources Management Act of 1978, as amended, (Louisiana R.S. 49:214.21-214.41), and the rules and regulations of the Coastal Resources Program. Applications for the proposed work may be inspected at 617 North 3rd Street, Room 1078, Baton Rouge, LA or on the OCM web page at: http://dnr.louisiana.gov/index.cfm?md=pagebuilder&tmp=home&pid=591. Copies may be obtained upon payment of cost of copying. Written comments, including suggestions for modifications or objections to the proposed work and stating the reasons thereof, are being solicited from the public. Comments must be received within 25 days of the date of publication of this notice. Comments should be uploaded to our electronic record, but may be mailed, faxed or emailed to the designated OCM Reviewer. All comments must contain the appropriate application number and the commenter's full name and contact information.

The comment period for the Department of Army will close in <u>30 days</u> from the date of this public notice. Written comments, including suggestions for modifications or objections to the proposed work, stating reasons thereof, are being solicited from anyone having interest in this permit and must be mailed so as to be received before or by the last day of the comment period. Letters concerning the Corps of Engineers permit application must reference the applicant's name and the Permit Application Number, and be mailed to the Corps of Engineers at the address above, <u>ATTENTION: REGULATORY BRANCH</u>. Similar letters concerning the Water Quality Certification must reference the applicant's name and the WQC Application number and be mailed to the Louisiana Department of Environmental Quality at the address above.

The application for this proposed project is on file with the Louisiana Department of Environmental Quality and may be examined during weekdays between 8:00 a.m. and 4:30 p.m. Copies may be obtained upon payment of costs of reproduction.

Corps of Engineers Permit Criteria

The decision whether to issue a permit will be based on an evaluation of the probable impacts, including cumulative impacts of the proposed activity on the public interest. That decision will reflect the national concern for both protection and utilization of important resources. The benefit which reasonably may be expected to accrue from the proposal must be balanced against its reasonably foreseeable detriments. All factors which may be relevant to the proposal will be considered including the cumulative effects thereof; among those are conservation, economics, aesthetics, general environmental concerns, wetlands, historic properties, fish and wildlife values, flood hazards, floodplain values, land use, navigation, shoreline erosion and accretion, recreation, water supply and conservation, water quality, energy needs, safety, food and fiber production, mineral needs, considerations of property ownership and, in general, the needs and welfare of the people.

The US Army Corps of Engineers is soliciting comments from the public, federal, state, and local agencies and officials, Indian Tribes, and other interested parties in order to consider and evaluate the impacts of this proposed activity. Any comments received will be considered by the US Army Corps of Engineers to determine whether to make, modify, condition, or deny a permit for this proposal. To make this decision, comments are used to assess impacts on endangered species, historic properties, water quality, general environmental effects, and other public interest factors listed above. Comments are used in the preparation of an Environmental Assessment and/or an Environmental Impact Statement pursuant to the National Environmental Policy Act. Comments are also used to determine the need for a public hearing and to determine the overall public interest of the proposed activity.

The New Orleans District is unaware of properties listed on the National Register of Historic Places near the proposed work. The possibility exists that the proposed work may damage or destroy presently unknown archeological, scientific, prehistorical, historical sites, or data. Issuance of this public notice solicits input from the State Archeologist and State Historic Preservation Officer regarding potential impacts to cultural resources.

Our initial finding is that the proposed work would neither affect any species listed as endangered by the U.S. Departments of Interior or Commerce, nor affect any habitat designated as critical to the survival and recovery of any endangered species.

This notice initiates the Essential Fish Habitat (EFH) consultation requirements of the Magnuson-Stevens Fishery Conservation and Management Act. The applicant's proposal would result in the destruction or alteration of up to <u>126.13</u> acres of EFH utilized by various life stages of red drum and penaeid shrimp. Our initial determination is that the proposed action would not have a substantial adverse impact on EFH or federally managed fisheries in the Gulf of Mexico. Our final determination relative to project impacts and the need for mitigation measures is subject to review by and coordination with the National Marine Fisheries Service.

If the proposed work involves deposits of dredged or fill material into navigable waters, the evaluation of the probable impacts will include the application of guidelines established by the Administrator of the Environmental Protection Agency. Also, a certification that the proposed activity will not violate water quality standards will be required from the Department of Environmental Quality, Office of Environmental Services before a permit is issued.

Any person may request, in writing, within the comment period specified in this notice, that a public hearing be held to consider this application. Requests for public hearings shall state, with particularity, the reasons for holding a public hearing. You are requested to communicate the information contained in this notice to any other parties whom you deem likely to have interest in the matter.

The applicant has certified that the proposed activity described in the application complies with and will be conducted in a manner that is consistent with the Louisiana Coastal Resources Program. The Department of the Army permit will not be issued unless the applicant received approval or a waiver of the Coastal Use Permit by the Department of Natural Resources.


JOHN M. HERMAN Chief, Central Evaluation Section Regulatory Branch

Enclosures

STATE OF LOUISIANA DEPARTMENT OF NATURAL RESOURCES COASTAL ENGINEERING DIVISION

RIVER REINTRODUCTION INTO MAUREPAS SWAMP

PROJECT NO. PO-29 ST. JOHN THE BAPTIST PARISH, LOUISIANA

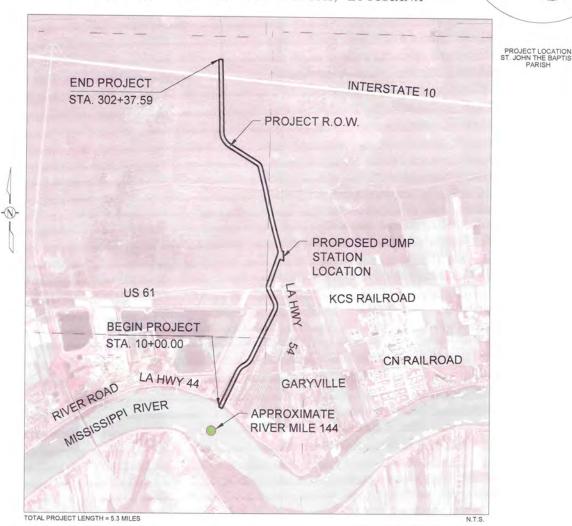







STATE PROJECT SPONSOR CONSULTANT PROJECT ENGINEER

CED DIRECTOR

STATE OF LOUISIANA INSET MAP

CED ENGINEER MANAGER

CED PROJECT ENGINEER



3500 N. Causeway Blvd., Suite 900 Metairie, Louisiana 70002 (504) 837-6326 COASTAL PROTECTION AND RESTORATION AUTHORITY 450 LAUREL STREET BATON ROUGE, LOUISIANA 70801 RIVER REINTRODUCTION INTO MAUREPAS SWAMP ST. JOHN THE BAPTIST PARISH, LOUISIANA

PROJECT NUMBER: 10001877

TITLE SHEET

DRAWN BY: APO

DESIGNED BY: CL

SHEET NO.

TITLE

River Reintroduction into Maurepas Swamp Joint Permit Application for Work within the Lousiana Coastal Zone

INDEX OF DRAWINGS

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|------------------------------------|------------------------|
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COASTAL PROTECTION AND RESTORATION AUTHORITY 450 LAUREL STREET BATON ROUGE, LOUISIANA 70801 RIVER REINTRODUCTION INTO MAUREPAS SWAMP ST. JOHN THE BAPTIST PARISH, LOUISIANA


PROJECT NUMBER: 10001877

INDEX OF DRAWINGS

DRAWN BY: APO DESIGNED BY: CL

SHEET NO.

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RESTORATION AUTHORITY 450 LAUREL STREET BATON ROUGE, LOUISIANA 70801

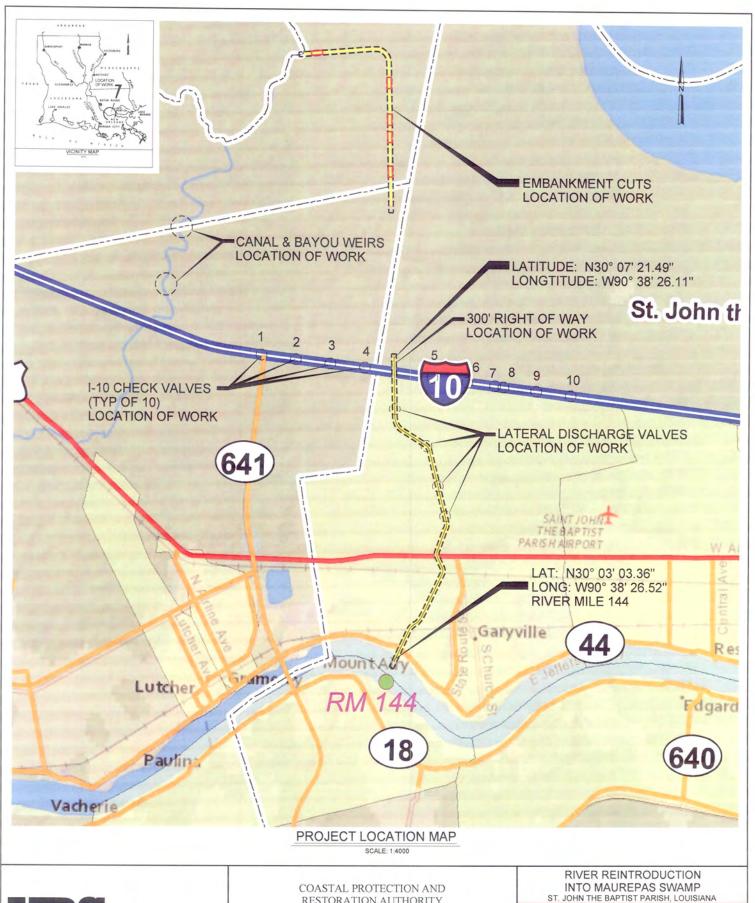PROJECT NUMBER: 10001877


VICINITY AND LOCATION MAPS


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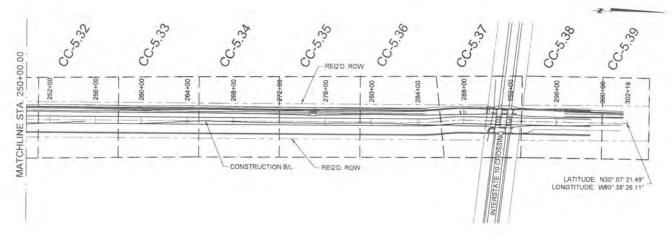
DESIGNED BY: CL

SHEET NO.

CC-1.1



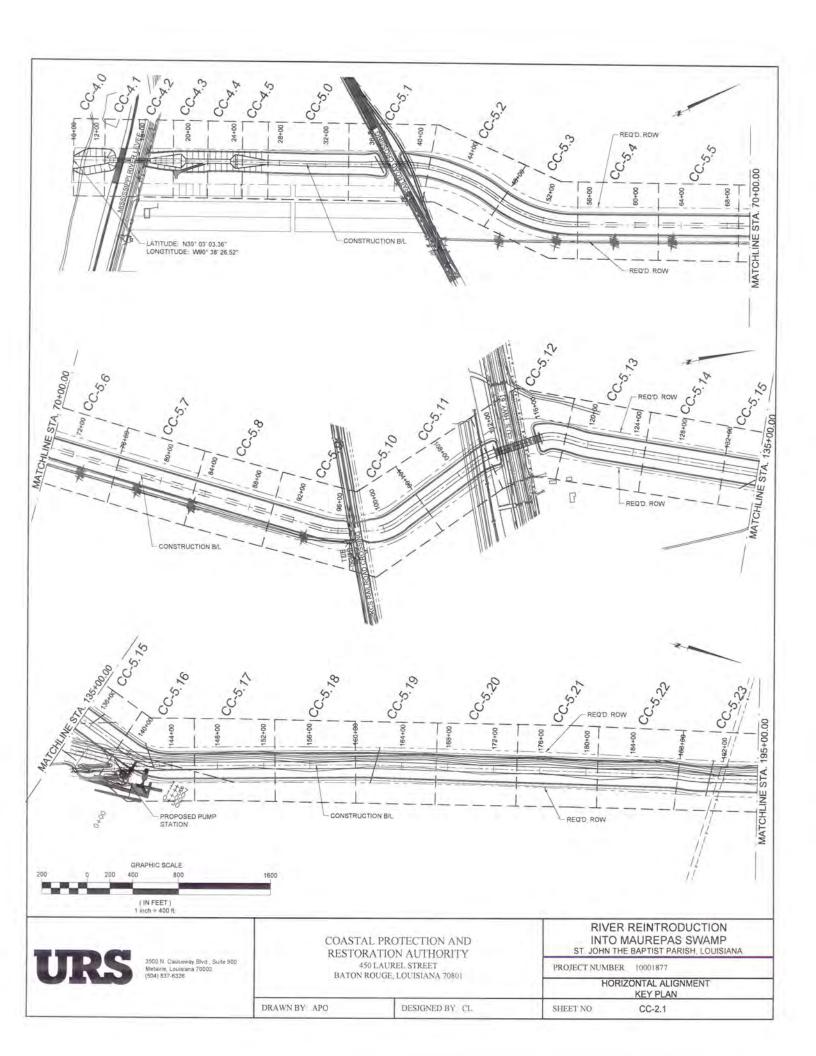

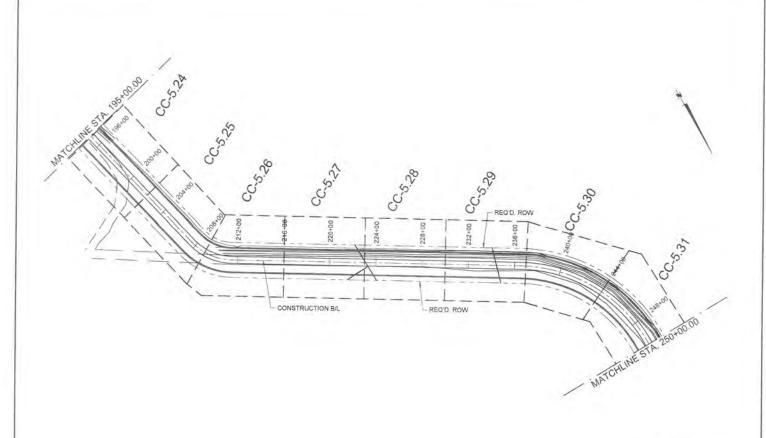



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3500 N. Causeway Bivd., Suite 900 Metaine, Louisiana 70002 (504) 837-6326 COASTAL PROTECTION AND RESTORATION AUTHORITY 450 LAUREL STREET BATON ROUGE, LOUISIANA 70801 RIVER REINTRODUCTION INTO MAUREPAS SWAMP ST. JOHN THE BAPTIST PARISH, LOUISIANA

PROJECT NUMBER: 10001877


HORIZONTAL ALIGNMENT KEY PLAN

DRAWN BY: APO

DESIGNED BY: CL.

SHEET NO.


CC-2.2

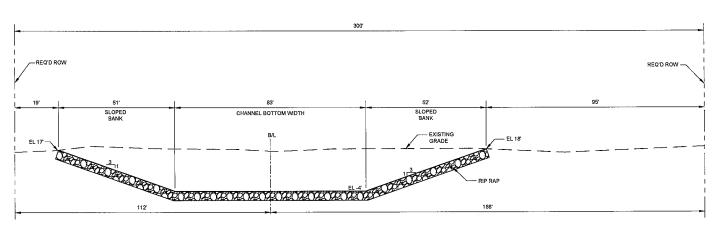

INTAKE CHANNEL

TYPICAL SECTION


NTS

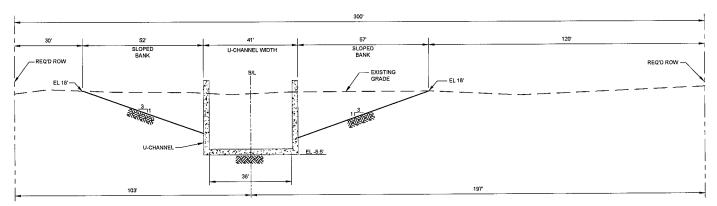

CONCRETE U-CHANNELS

TYPICAL SECTION

NTS

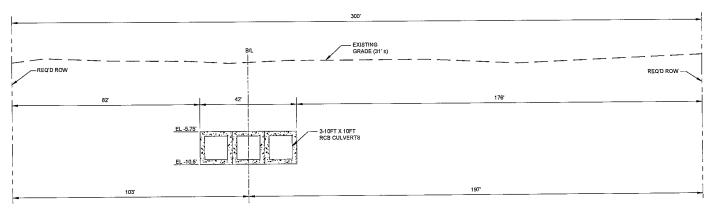

LEVEE CROSSING

TYPICAL SECTION

NTS

GENERAL NOTES:

- DEEP SOIL MIXING SHALL BE REQUIRED FOR PORTIONS OF THE SEDIMENTATION BASIN AREA.
- TOP OF LEVEE WILL BE UTILIZED FOR LIGHT TRUCK ACCESS, IN ORDER TO MONITOR LENGTH OF CONVEYANCE CHANNEL. THIS 10' WIDE LEVEE AREA SHALL HAVE A 6" SECTION OF CRUSHED GRAVEL.
- 3. THE PROPOSED FENCING IS REQUIRED ADJACENT TO RESIDENTIAL AREAS AS A VISUAL BUFFER.

URS

3500 N. Causeway Blvd., Suite 900 Metairie, Louisiana 70002 (504) 837-6326 COASTAL PROTECTION AND RESTORATION AUTHORITY

450 LAUREL STREET BATON ROUGE, LOUISIANA 70801

DRAWN BY: APO

DESIGNED BY: CL


RIVER REINTRODUCTION INTO MAUREPAS SWAMP ST. JOHN THE BAPTIST PARISH, LOUISIANA

PROJECT NUMBER: 10001877

INTAKE CHANNEL TO LEVEE CROSSING TYPICAL SECTIONS

SHEET NO.


CC-3.1

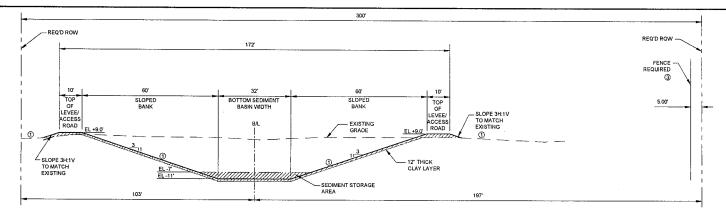

SEDIMENT BASIN

TYPICAL SECTION


NTS

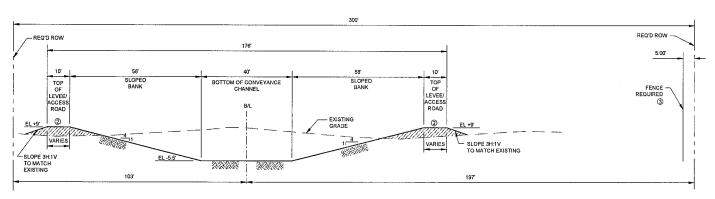

CONVEYANCE CHANNEL

SEDIMENTATION BASIN TO CN RAILROAD

TYPICAL SECTION NTS

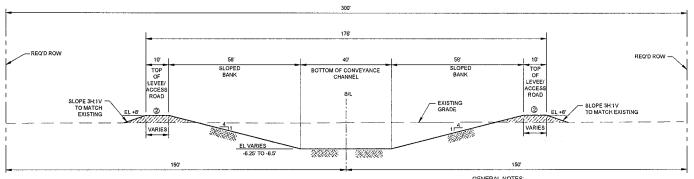

CONVEYANCE CHANNEL

CN RAILROAD TO KCS RAILROAD

TYPICAL SECTION

NTS

GENERAL NOTES:

- DEEP SOIL MIXING SHALL BE REQUIRED FOR PORTIONS OF THE SEDIMENTATION BASIN AREA.
- TOP OF LEVEE WILL BE UTILIZED FOR LIGHT TRUCK ACCESS, IN ORDER TO MONITOR LENGTH OF CONVEYANCE CHANNEL. THIS 10' WIDE LEVEE AREA SHALL HAVE A 6" SECTION OF CRUSHED GRAVEL.
- THE PROPOSED FENCING IS REQUIRED ADJACENT TO RESIDENTIAL AREAS AS A VISUAL BUFFER.

COASTAL PROTECTION AND RESTORATION AUTHORITY 450 LAUREL STREET BATON ROUGE, LOUISIANA 70801

RIVER REINTRODUCTION INTO MAUREPAS SWAMP ST. JOHN THE BAPTIST PARISH, LOUISIANA

PROJECT NUMBER: 10001877


SEDIMENT BASIN TO KCS RR TYPICAL SECTIONS

DRAWN BY: APO

DESIGNED BY: CL

SHEET NO

CC-3.2

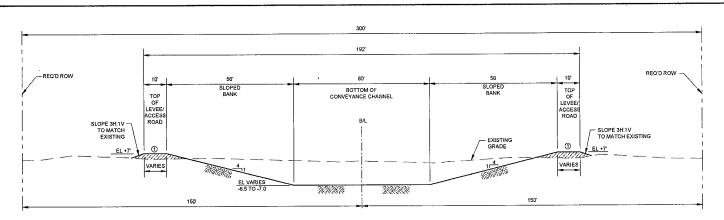


CONVEYANCE CHANNEL

KCS RAILROAD TO AIRLINE HWY

TYPICAL SECTION

NTS

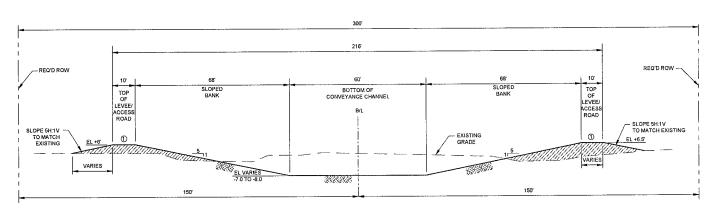


CONVEYANCE CHANNEL

AIRLINE HWY TO INTERSTATE 10

TYPICAL SECTION

NTS

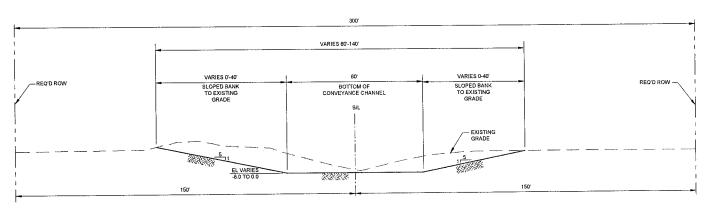

NORTH OF INTERSTATE 10

TYPICAL SECTION

NTS

GENERAL NOTES:

 TOP OF LEVEE WILL BE UTILIZED FOR LIGHT TRUCK ACCESS, IN ORDER TO MONITOR LENGTH OF CONVEYANCE CHANNEL. THIS 10' WIDE LEVEE AREA SHALL HAVE A 6" SECTION OF CRUSHED GRAVEL, WITH THE EXCEPTION OF THE AREA NORTH OF INTERSTATE 10.



3500 N. Causeway Blvd., Suite 900 Metairie, Louisiana 70002 (504) 837-6326 COASTAL PROTECTION AND RESTORATION AUTHORITY 450 LAUREL STREET BATON ROUGE, LOUISIANA 70801 RIVER REINTRODUCTION INTO MAUREPAS SWAMP ST. JOHN THE BAPTIST PARISH, LOUISIANA

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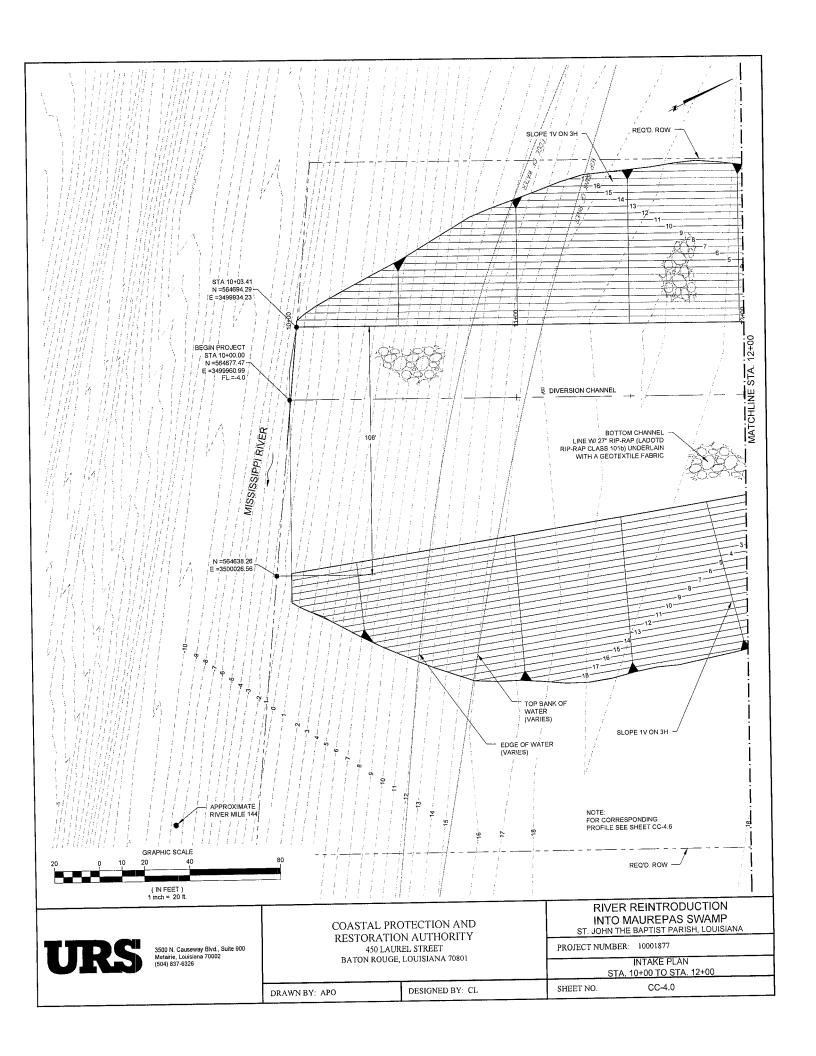
KCS RR TO N OF I-10 TYPICAL SECTIONS


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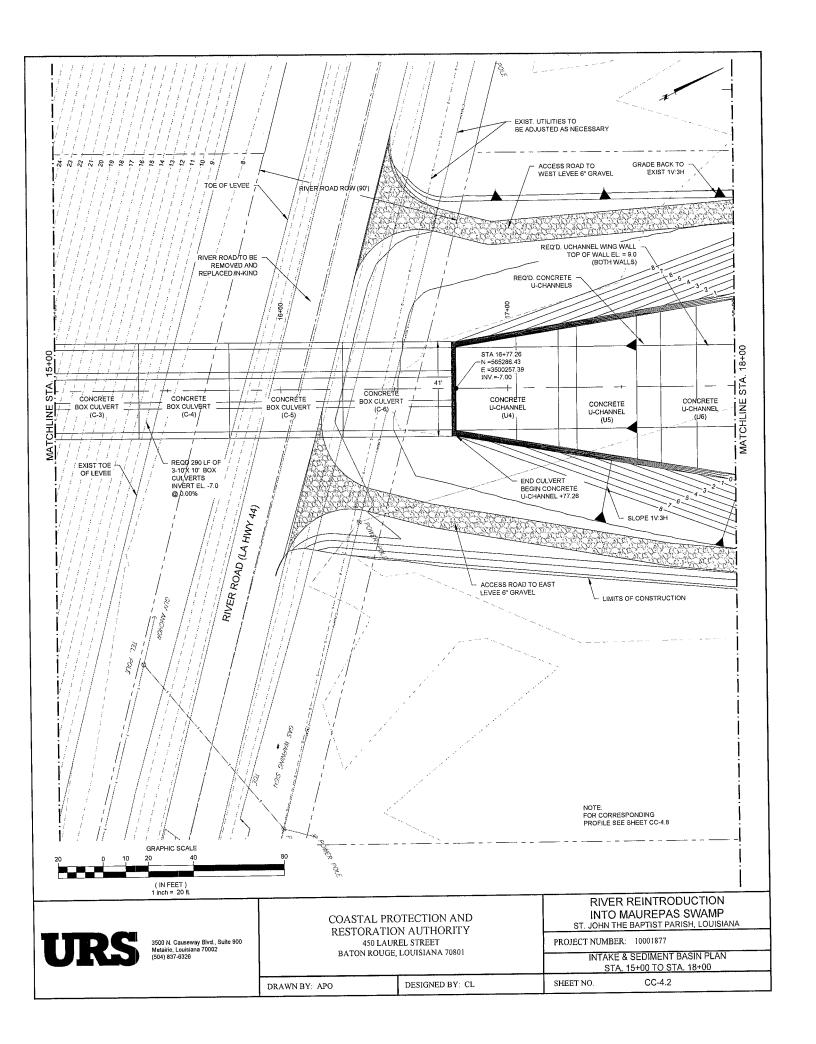
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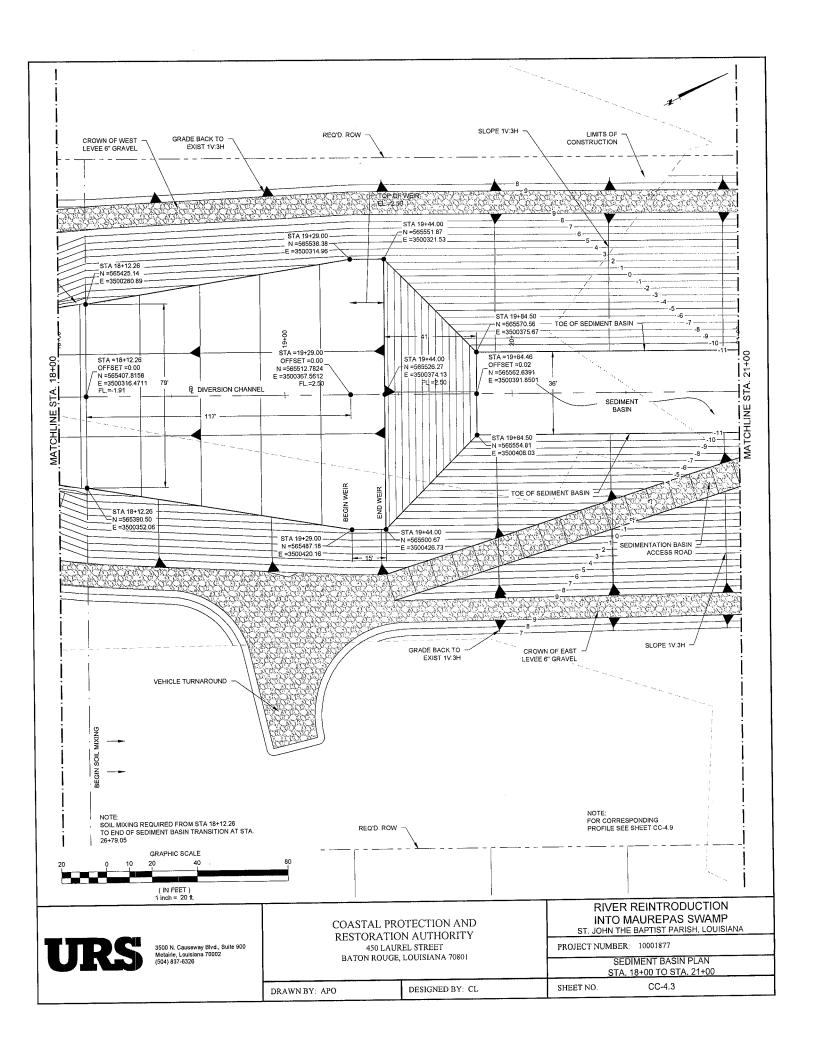
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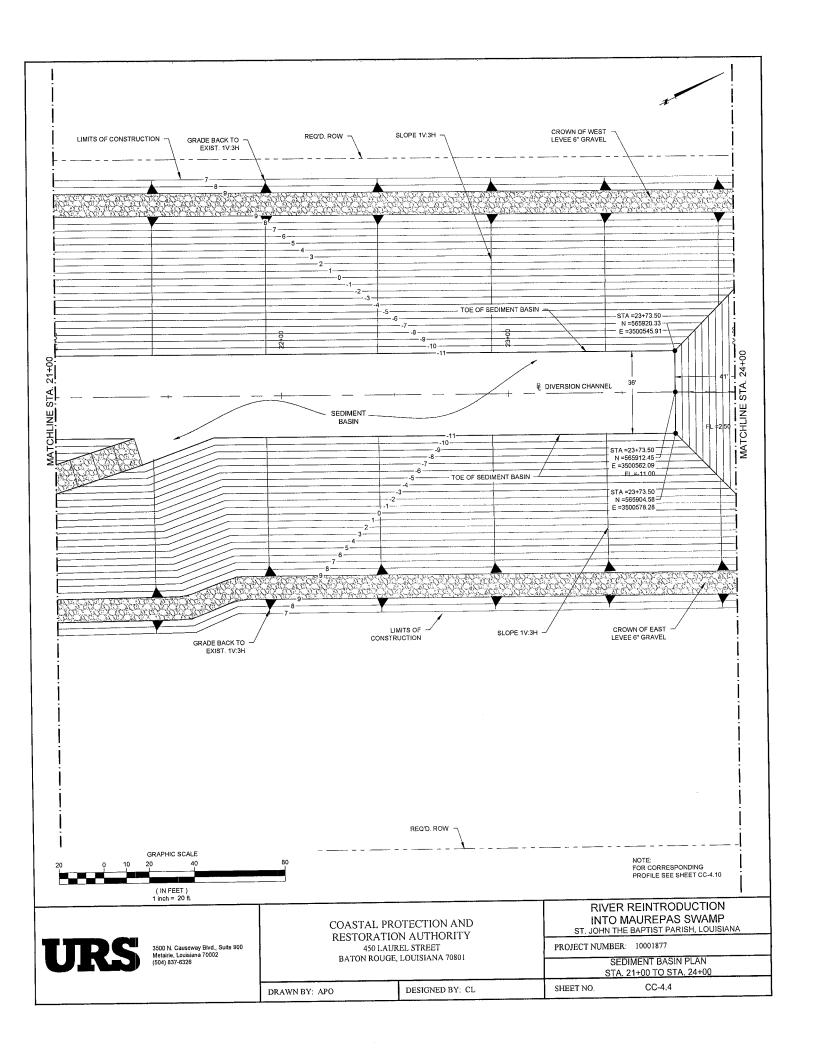
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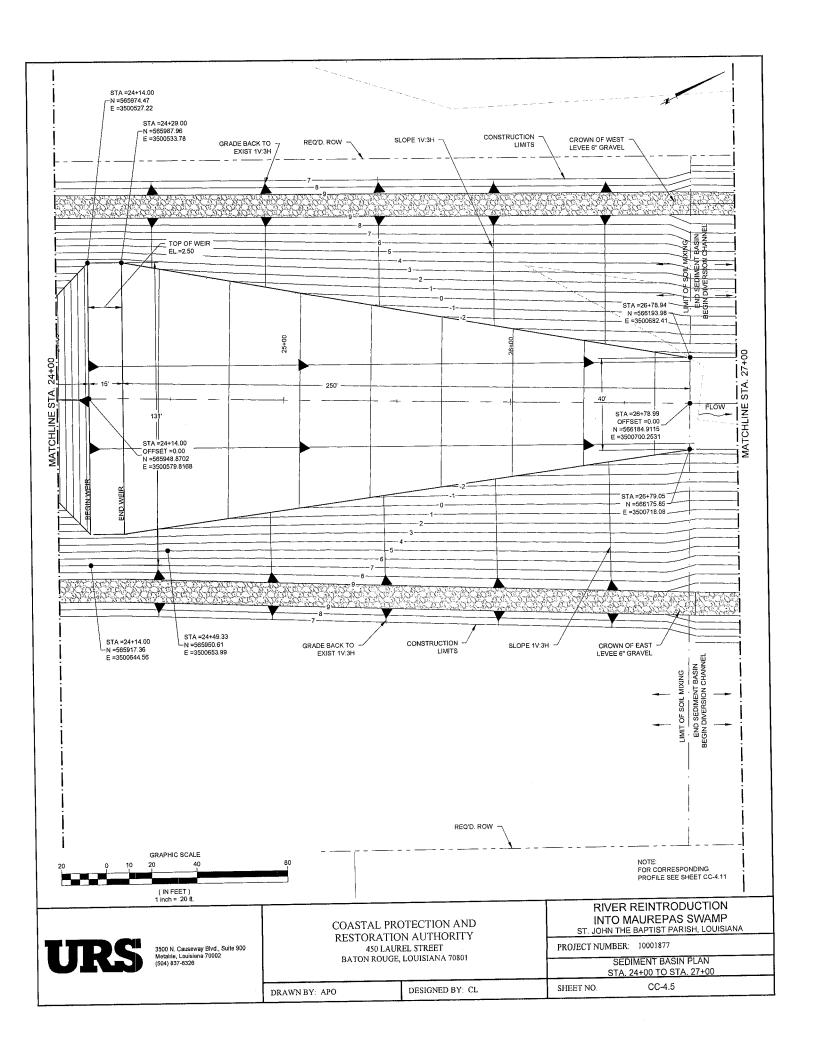












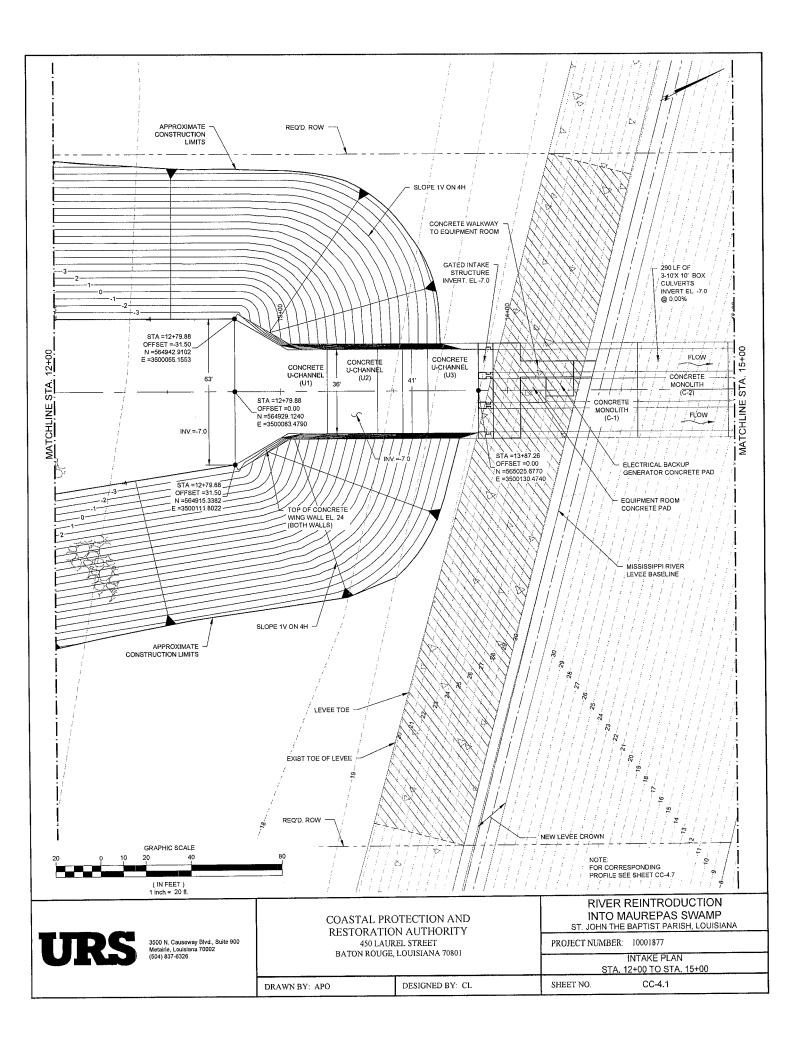

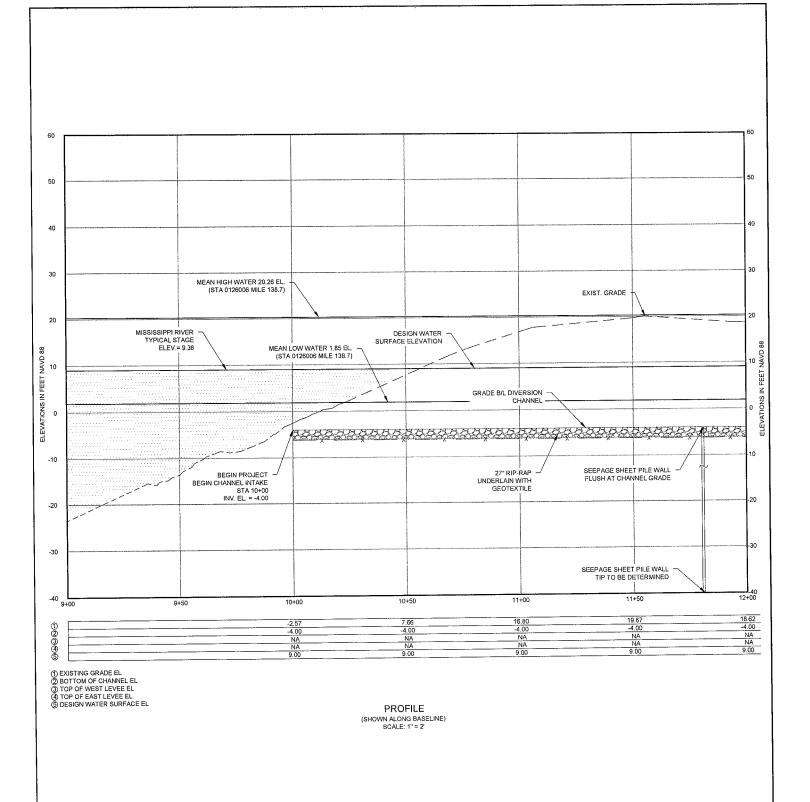

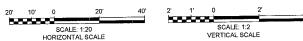

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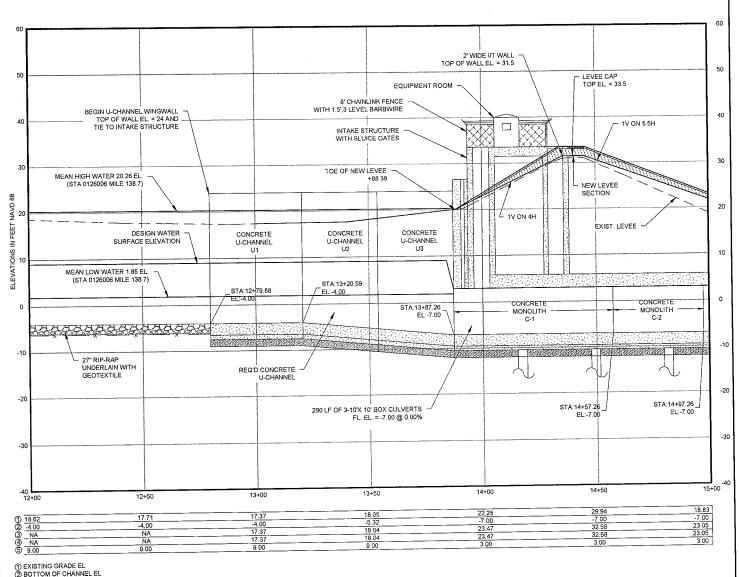
INTAKE PROFILE STA. 10+00 TO STA. 12+00

DRAWN BY: APO DESIGNED

DESIGNED BY: CL

SHEET NO.

CC-4.6



PROFILE (SHOWN ALONG BASELINE) SCALE: 1" = 2"





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COASTAL PROTECTION AND RESTORATION AUTHORITY 450 LAUREL STREET BATON ROUGE, LOUISIANA 70801

RIVER REINTRODUCTION INTO MAUREPAS SWAMP ST. JOHN THE BAPTIST PARISH, LOUISIANA

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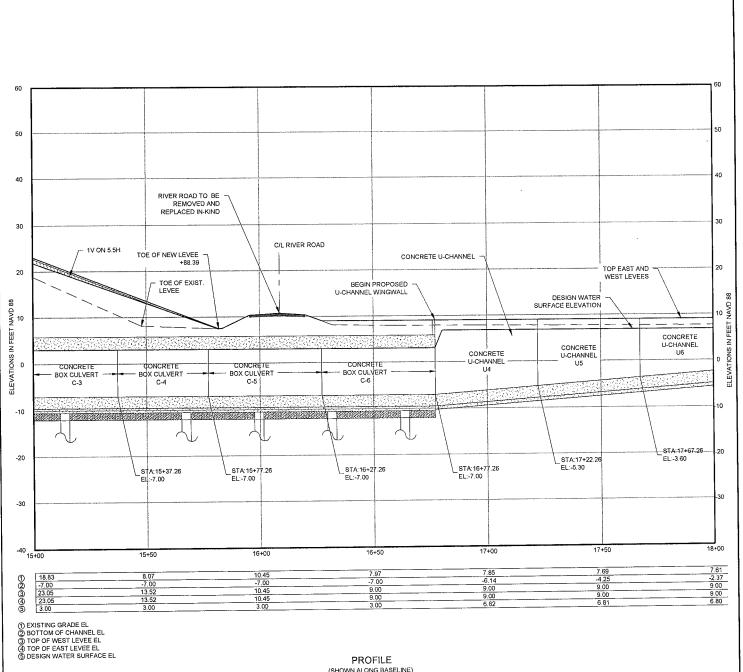
INTAKE PROFILE STA. 12+00 TO STA. 15+00

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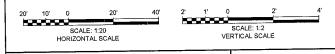
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SHEET NO.

CC-4.7



(SHOWN ALONG BASELINE) SCALE: 1" = 2'



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COASTAL PROTECTION AND RESTORATION AUTHORITY 450 LAUREL STREET BATON ROUGE, LOUISIANA 70801

RIVER REINTRODUCTION INTO MAUREPAS SWAMP ST. JOHN THE BAPTIST PARISH, LOUISIANA


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INTAKE PROFILE STA. 15+00 TO STA. 18+00


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DESIGNED BY: CL

CC-4.8 SHEET NO.



PROFILE (SHOWN ALONG BASELINE) SCALE: 1" = 2"

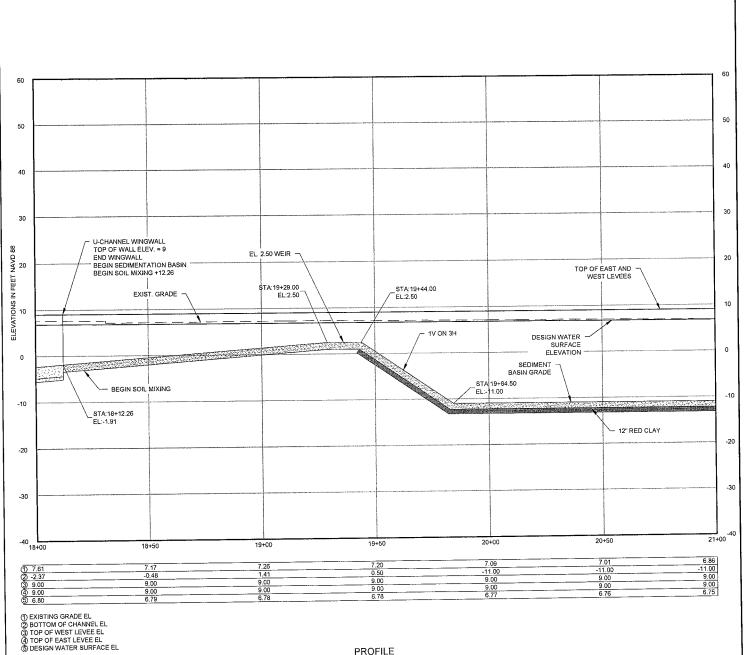
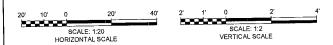
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DRAWN BY: APO

COASTAL PROTECTION AND RESTORATION AUTHORITY 450 LAUREL STREET

DESIGNED BY: CL


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SEDIMENT BASIN PROFILE STA. 18+00 TO STA. 21+00 CC-4.9 SHEET NO.


RIVER REINTRODUCTION INTO MAUREPAS SWAMP

ST. JOHN THE BAPTIST PARISH, LOUISIANA

BATON ROUGE, LOUISIANA 70801

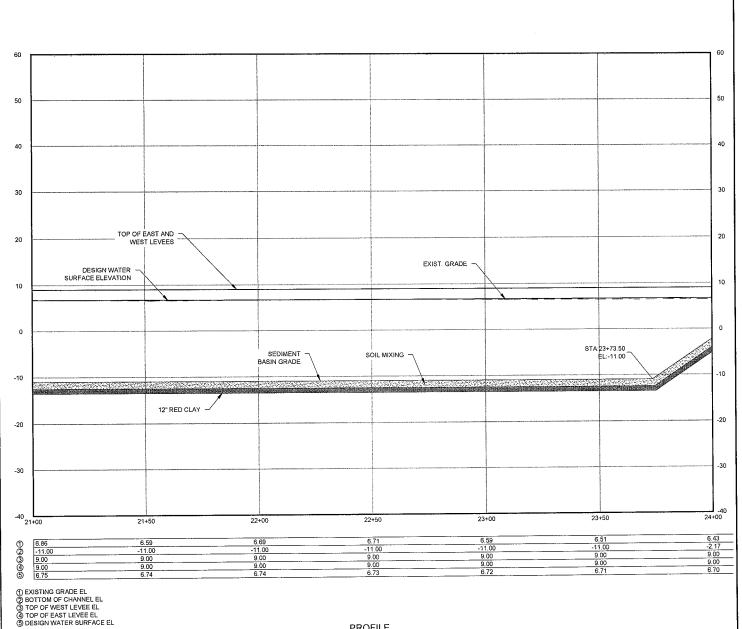

PROFILE (SHOWN ALONG BASELINE) SCALE: 1" = 2'

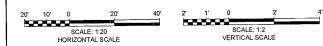



3500 N. Causeway Blvd., Suite 900 Metairie, Louisiana 70002 (504) 837-6326 COASTAL PROTECTION AND RESTORATION AUTHORITY 450 LAUREL STREET BATON ROUGE, LOUISIANA 70801 RIVER REINTRODUCTION INTO MAUREPAS SWAMP ST. JOHN THE BAPTIST PARISH, LOUISIANA

PROJECT NUMBER: 10001877


SEDIMENT BASIN PROFILE STA. 21+00 TO STA. 24+00

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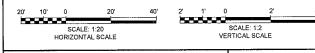
DESIGNED BY: CL

SHEET NO.

CC-4.10

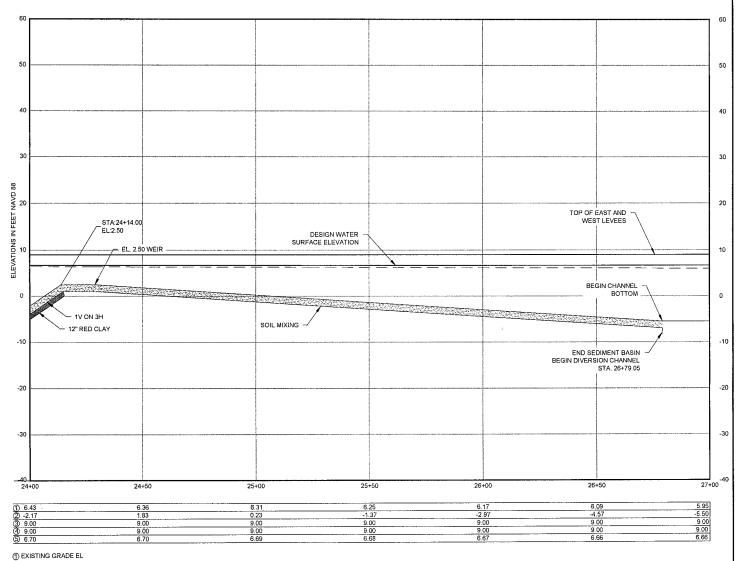

PROFILE (SHOWN ALONG BASELINE) SCALE: 1" = 2'



COASTAL PROTECTION AND RESTORATION AUTHORITY 450 LAUREL STREET

BATON ROUGE, LOUISIANA 70801

RIVER REINTRODUCTION INTO MAUREPAS SWAMP ST. JOHN THE BAPTIST PARISH, LOUISIANA


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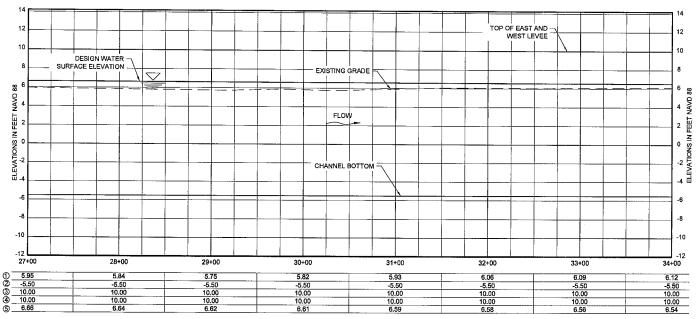
SEDIMENT BASIN PROFILE STA. 24+00 TO STA. 27+00

DESIGNED BY: CL DRAWN BY: APO

SHEET NO.

CC-4.11



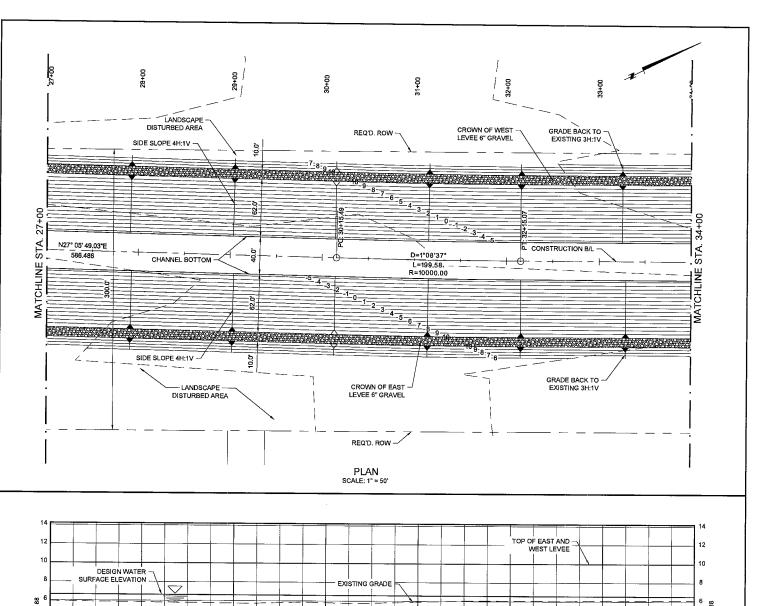

PROFILE (SHOWN ALONG BASELINE) SCALE: 1" = 5' 100' 50' 0 100' 200 SCALE: 1:100 HORIZONTAL SCALE 10' 5' 0 10' 20

SCALE: 1:10

VERTICAL SCALE

URS

3500 N. Causeway Blvd., Suite 900 Metairie, Louisiana 70002 (504) 837-6326 COASTAL PROTECTION AND RESTORATION AUTHORITY 450 LAUREL STREET BATON ROUGE, LOUISIANA 70801

INTO MAUREPAS SWAMP ST. JOHN THE BAPTIST PARISH, LOUISIANA

PROJECT NUMBER: 10001877


PLAN AND PROFILE


RIVER REINTRODUCTION

DRAWN BY: APO

DESIGNED BY: CL

SHEET NO.

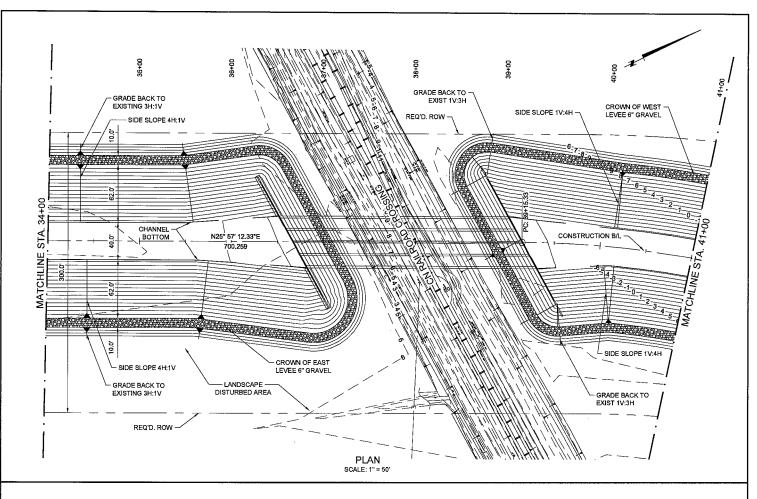

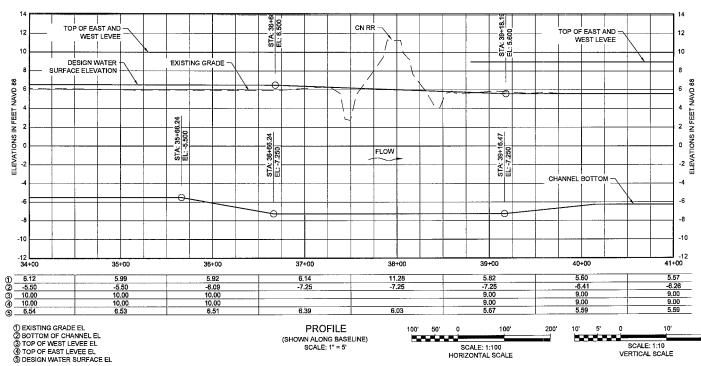

COASTAL PROTECTION AND RESTORATION AUTHORITY 450 LAUREL STREET

(SHOWN ALONG BASELINE) SCALE: 1" = 5'

BATON ROUGE, LOUISIANA 70801

INTO MAUREPAS SWAMP ST. JOHN THE BAPTIST PARISH, LOUISIANA

SCALE: 1:10 VERTICAL SCALE

PROJECT NUMBER: 10001877

PLAN AND PROFILE

RIVER REINTRODUCTION


20'


DRAWN BY: APO

DESIGNED BY: CL

SHEET NO.

SCALE: 1:100 HORIZONTAL SCALE

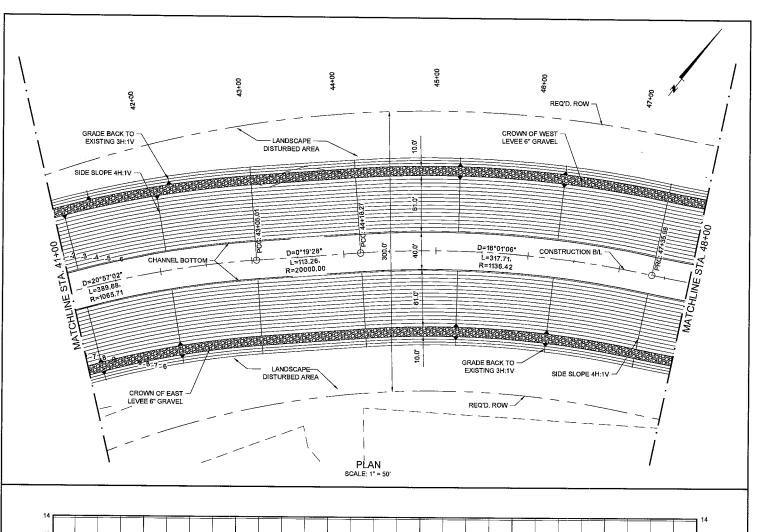

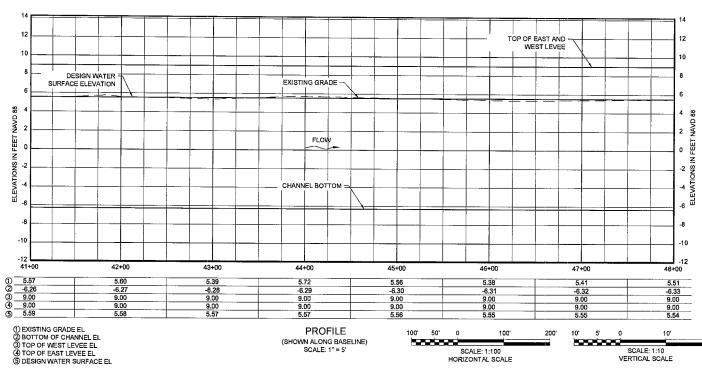

COASTAL PROTECTION AND RESTORATION AUTHORITY 450 LAUREL STREET BATON ROUGE, LOUISIANA 70801

(SHOWN ALONG BASELINE) SCALE: 1" = 5'

RIVER REINTRODUCTION INTO MAUREPAS SWAMP ST. JOHN THE BAPTIST PARISH, LOUISIANA

SCALE: 1:10

VERTICAL SCALE

PROJECT NUMBER: 10001877

PLAN AND PROFILE


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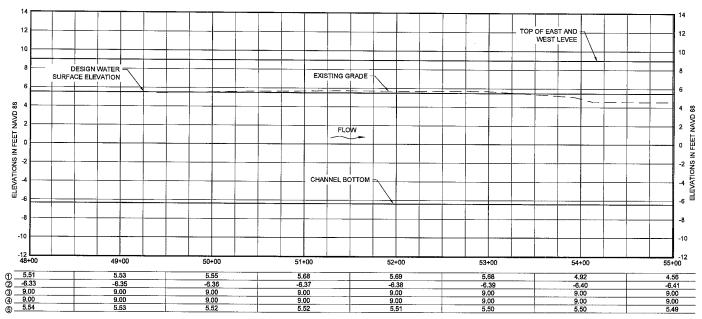
DESIGNED BY: CL

SCALE: 1:100

HORIZONTAL SCALE

SHEET NO.



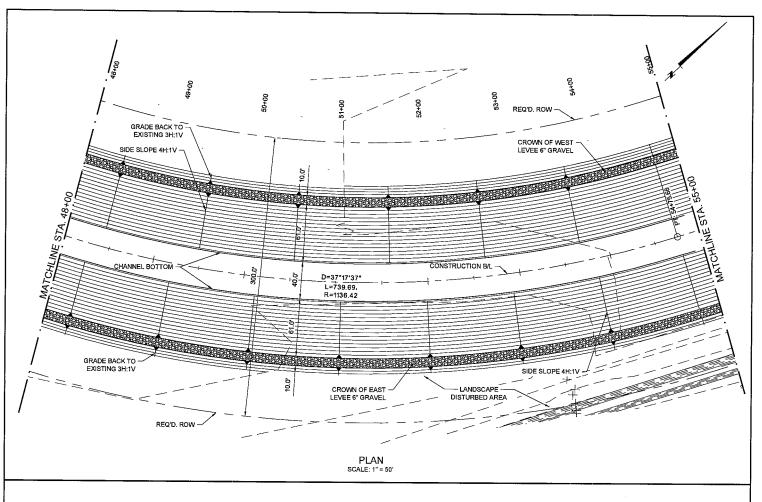

PROFILE (SHOWN ALONG BASELINE) SCALE: 1" = 5' 100' 50' 0 100' 200'

SCALE: 1:100

HORIZONTAL SCALE

10' 5' 0 10' 2

SCALE: 1:10

VERTICAL SCALE



3500 N. Causeway Blvd., Suite 900 Metairie, Louisiana 70002 (504) 837-6326 COASTAL PROTECTION AND RESTORATION AUTHORITY 450 LAUREL STREET

450 LAUREL STREET BATON ROUGE, LOUISIANA 70801

DRAWN BY: APO


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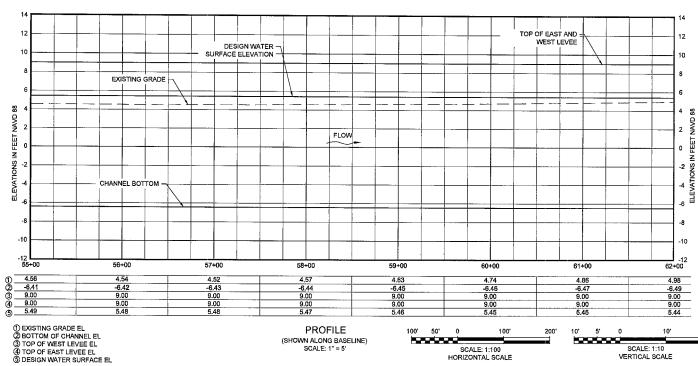
RIVER REINTRODUCTION INTO MAUREPAS SWAMP ST. JOHN THE BAPTIST PARISH, LOUISIANA

PROJECT NUMBER: 10001877

PLAN AND PROFILE

SHEET NO. CC-5.3



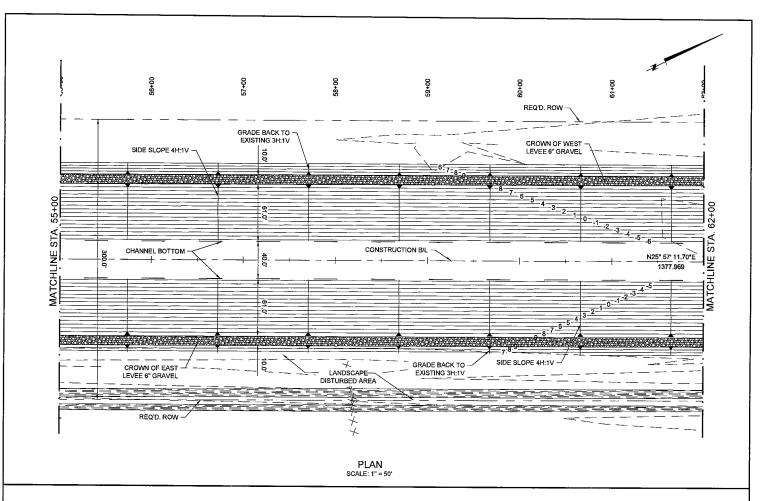

COASTAL PROTECTION AND RESTORATION AUTHORITY 450 LAUREL STREET

BATON ROUGE, LOUISIANA 70801

RIVER REINTRODUCTION INTO MAUREPAS SWAMP ST. JOHN THE BAPTIST PARISH, LOUISIANA

SCALE: 1:10

VERTICAL SCALE

PROJECT NUMBER: 10001877

200

PLAN AND PROFILE


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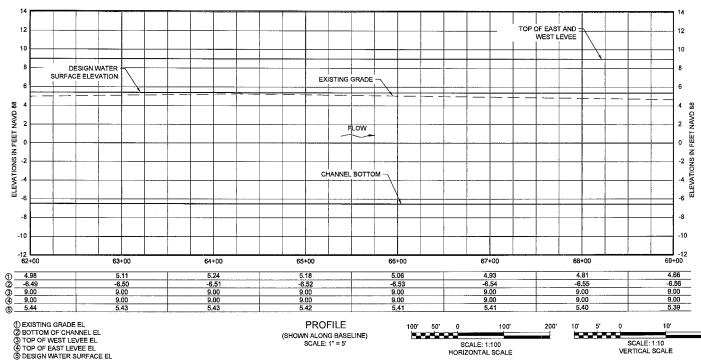
(SHOWN ALONG BASELINE) SCALE: 1" = 5'

SHEET NO.

SCALE: 1:100

HORIZONTAL SCALE



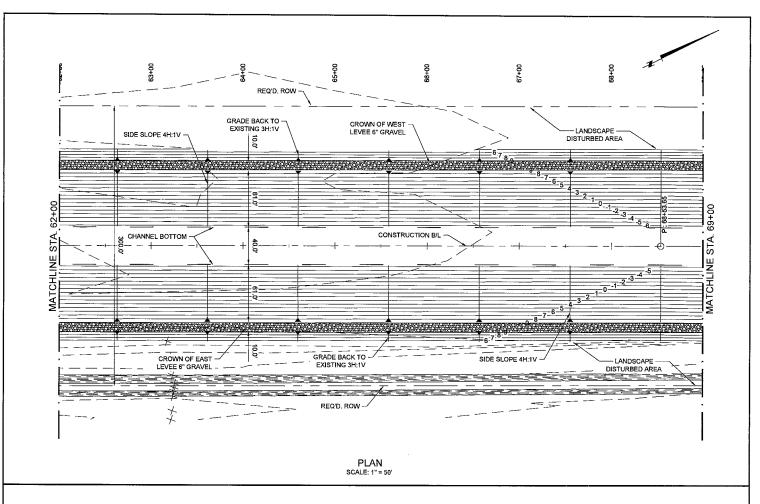

COASTAL PROTECTION AND RESTORATION AUTHORITY 450 LAUREL STREET

PROFILE (SHOWN ALONG BASELINE) SCALE: 1" = 5'

BATON ROUGE, LOUISIANA 70801

RIVER REINTRODUCTION INTO MAUREPAS SWAMP ST. JOHN THE BAPTIST PARISH, LOUISIANA


SCALE: 1:10 VERTICAL SCALE


PROJECT NUMBER: 10001877

PLAN AND PROFILE

CC-5.5 DRAWN BY: APO DESIGNED BY: CL SHEET NO.

SCALE: 1:100 HORIZONTAL SCALE

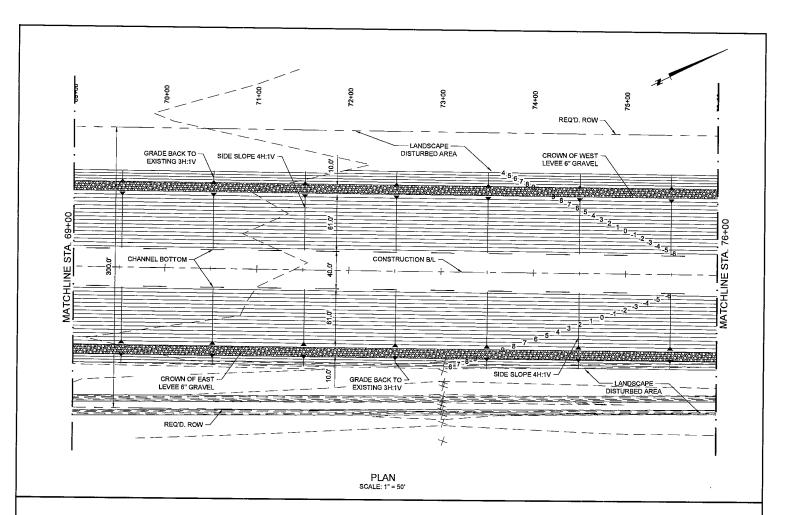

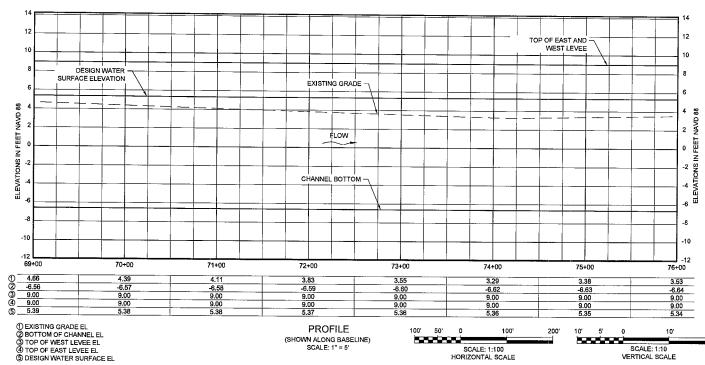

COASTAL PROTECTION AND RESTORATION AUTHORITY 450 LAUREL STREET BATON ROUGE, LOUISIANA 70801

(SHOWN ALONG BASELINE) SCALE: 1" = 5'

RIVER REINTRODUCTION INTO MAUREPAS SWAMP ST. JOHN THE BAPTIST PARISH, LOUISIANA


SCALE: 1:10 VERTICAL SCALE

PROJECT NUMBER: 10001877

PLAN AND PROFILE

DRAWN BY: APO DESIGNED BY: CL SHEET NO.

SCALE: 1:100 HORIZONTAL SCALE

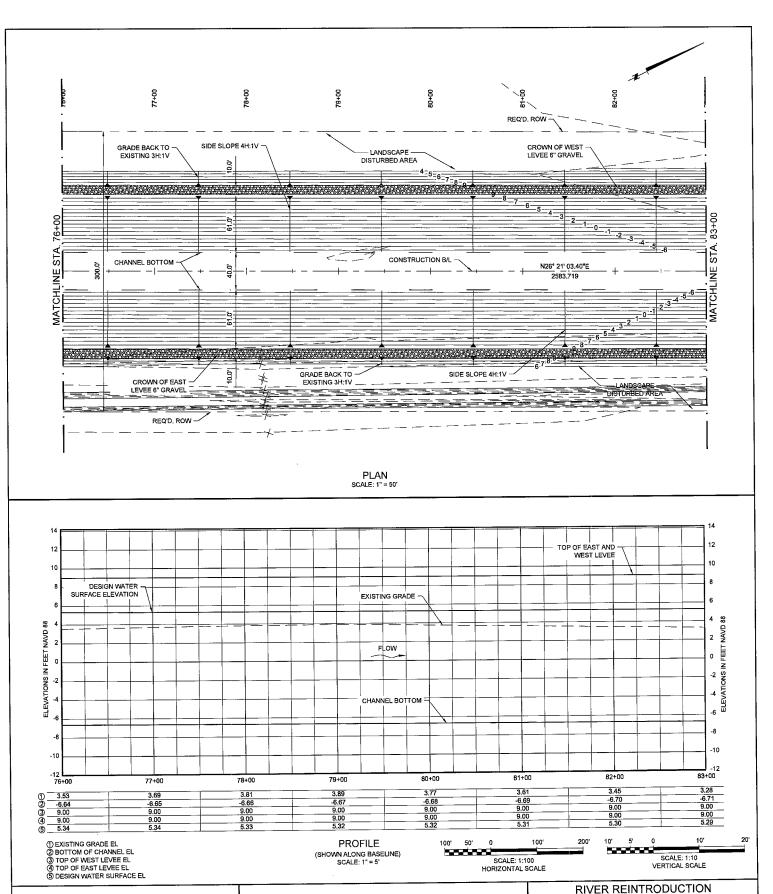



COASTAL PROTECTION AND RESTORATION AUTHORITY 450 LAUREL STREET

450 LAUREL STREET BATON ROUGE, LOUISIANA 70801 INTO MAUREPAS SWAMP ST. JOHN THE BAPTIST PARISH, LOUISIANA


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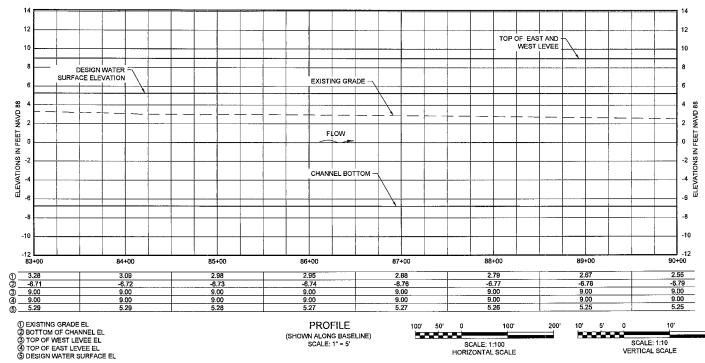
PLAN AND PROFILE

DRAWN BY: APO

DESIGNED BY: CL

SHEET NO.



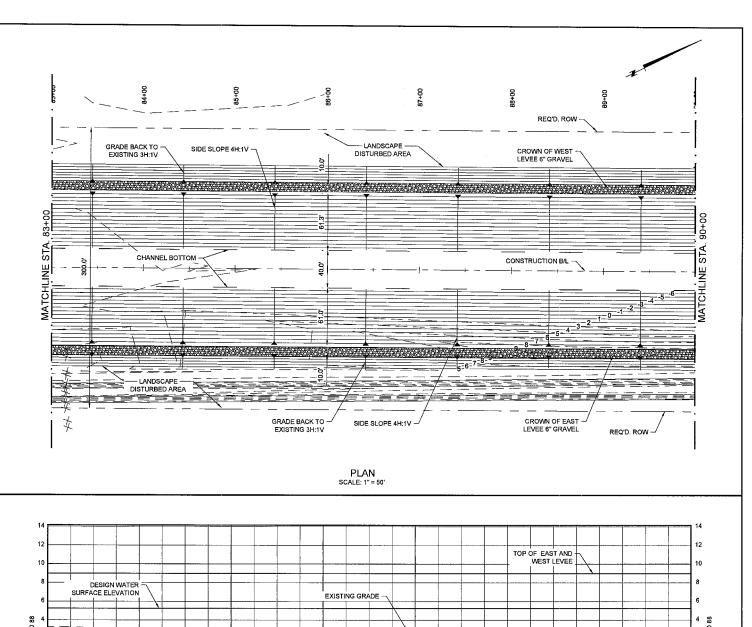

COASTAL PROTECTION AND RESTORATION AUTHORITY

450 LAUREL STREET BATON ROUGE, LOUISIANA 70801

RIVER REINTRODUCTION INTO MAUREPAS SWAMP ST. JOHN THE BAPTIST PARISH, LOUISIANA

SCALE: 1:10 VERTICAL SCALE

PROJECT NUMBER: 10001877


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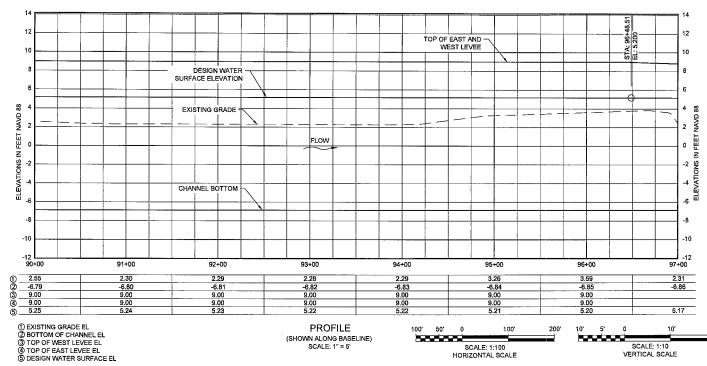
DRAWN BY: APO DESIGNED BY: CL

(SHOWN ALONG BASELINE) SCALE: 1" = 5'

SHEET NO.

SCALE: 1:100 HORIZONTAL SCALE



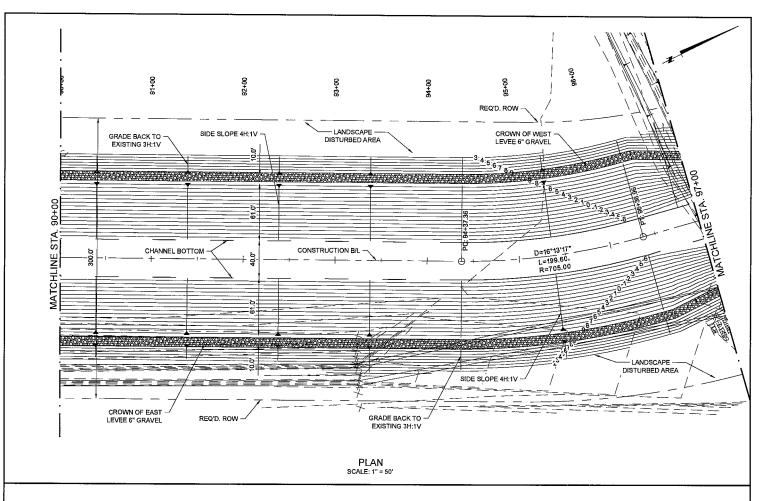



COASTAL PROTECTION AND RESTORATION AUTHORITY 450 LAUREL STREET BATON ROUGE, LOUISIANA 70801

SCALE: 1:100 HORIZONTAL SCALE

RIVER REINTRODUCTION INTO MAUREPAS SWAMP ST. JOHN THE BAPTIST PARISH, LOUISIANA

SCALE: 1:10 VERTICAL SCALE 20'

PROJECT NUMBER: 10001877


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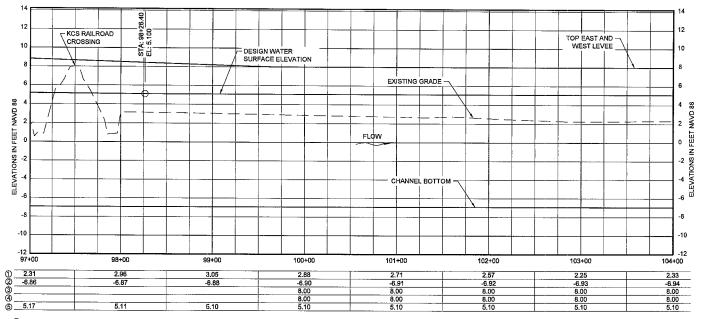
DESIGNED BY: CL DRAWN BY: APO

(SHOWN ALONG BASELINE)

SCALE: 1" = 5'

CC-5.9 SHEET NO.



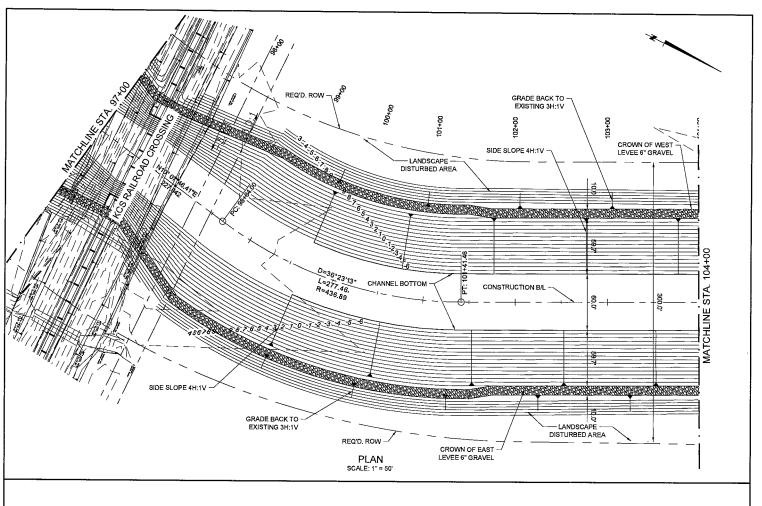

PROFILE (SHOWN ALONG BASELINE) SCALE: 1" = 5' 100' 50' 0 100' 200'

SCALE: 1:100

HORIZONTAL SCALE

0' 5' 0 10' 20'

SCALE: 1:10

VERTICAL SCALE

URS

3500 N. Causeway Blvd., Suite 900 Metairie, Louisiana 70002 (504) 837-6326 COASTAL PROTECTION AND RESTORATION AUTHORITY 450 LAUREL STREET BATON ROUGE, LOUISIANA 70801 RIVER REINTRODUCTION INTO MAUREPAS SWAMP ST. JOHN THE BAPTIST PARISH, LOUISIANA


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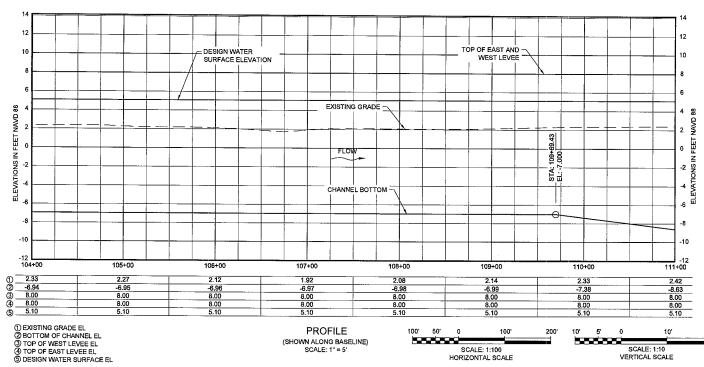
PLAN AND PROFILE

DRAWN BY: APO

DESIGNED BY: CL

SHEET NO. CC-5.10



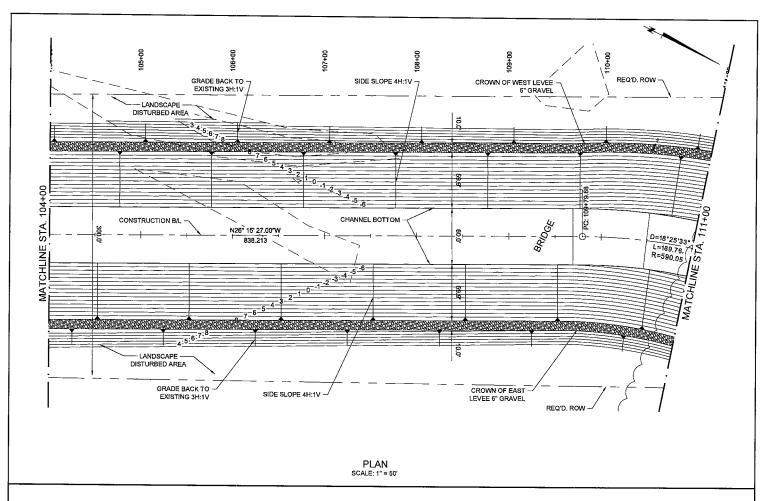

COASTAL PROTECTION AND RESTORATION AUTHORITY 450 LAUREL STREET BATON ROUGE, LOUISIANA 70801

PROFILE

(SHOWN ALONG BASELINE) SCALE: 1" = 5'

DRAWN BY: APO

RIVER REINTRODUCTION INTO MAUREPAS SWAMP ST. JOHN THE BAPTIST PARISH, LOUISIANA

SCALE: 1:10 VERTICAL SCALE


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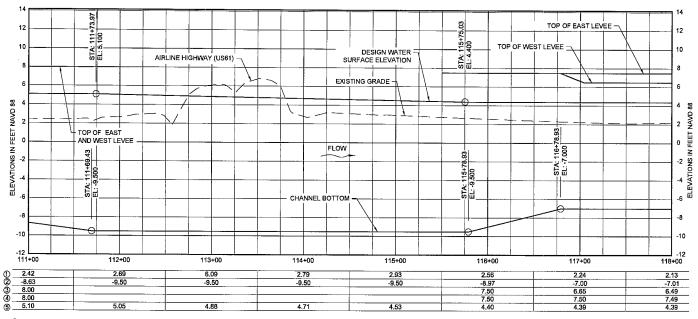
PLAN AND PROFILE

DESIGNED BY: CL

SCALE: 1:100 HORIZONTAL SCALE

SHEET NO.



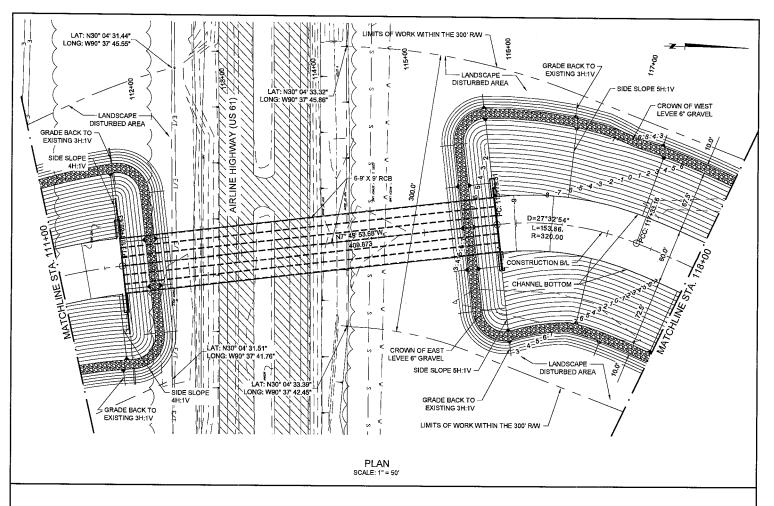

PROFILE (SHOWN ALONG BASELINE) SCALE: 1" = 5'

100' 50' 0 100' 200'

SCALE: 1:100

HORIZONTAL SCALE

10' 5' 0 10' 20'

SCALE: 1:10

VERTICAL SCALE

URS

3500 N. Causeway Blvd., Suite 900 Metairie, Louisiana 70002 (504) 837-6326 COASTAL PROTECTION AND RESTORATION AUTHORITY 450 LAUREL STREET BATON ROUGE, LOUISIANA 70801 RIVER REINTRODUCTION INTO MAUREPAS SWAMP ST. JOHN THE BAPTIST PARISH, LOUISIANA


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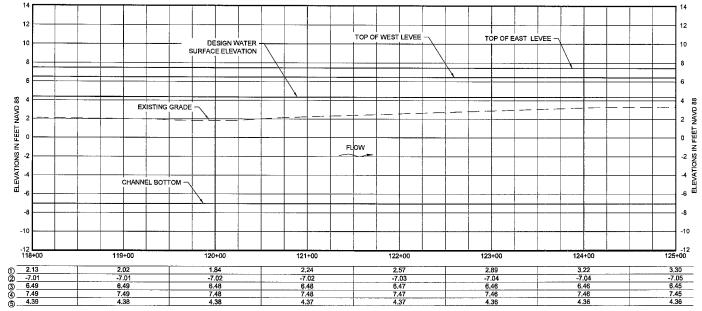
PLAN AND PROFILE

DRAWN BY: APO

DESIGNED BY: CL

SHEET NO.



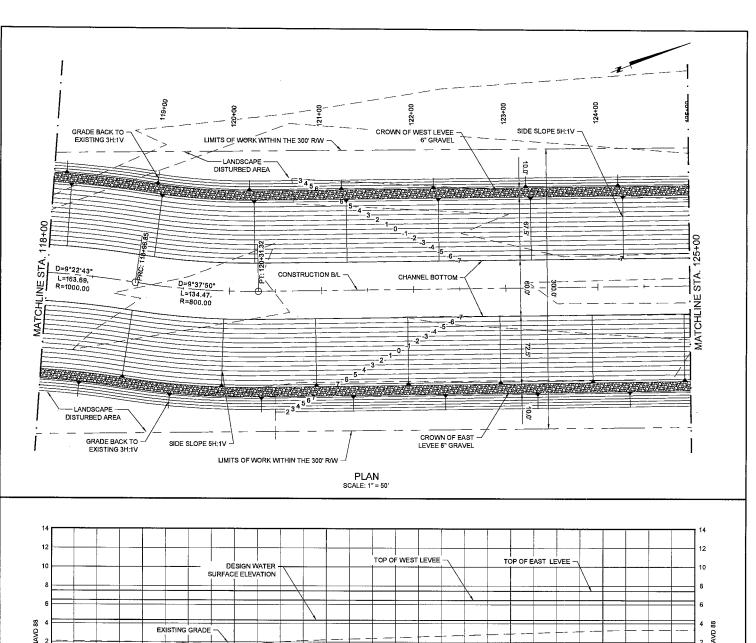

PROFILE (SHOWN ALONG BASELINE) SCALE: 1" = 5' 100' 50' 0 100' 200' SCALE: 1:100 HORIZONTAL SCALE 10' 5' 0 10' 20 SCALE: 1:10 VERTICAL SCALE



3500 N. Causeway Blvd., Suite 900 Metairie, Louislana 70002 (504) 837-6326 COASTAL PROTECTION AND RESTORATION AUTHORITY 450 LAUREL STREET BATON ROUGE, LOUISIANA 70801 RIVER REINTRODUCTION INTO MAUREPAS SWAMP ST. JOHN THE BAPTIST PARISH, LOUISIANA


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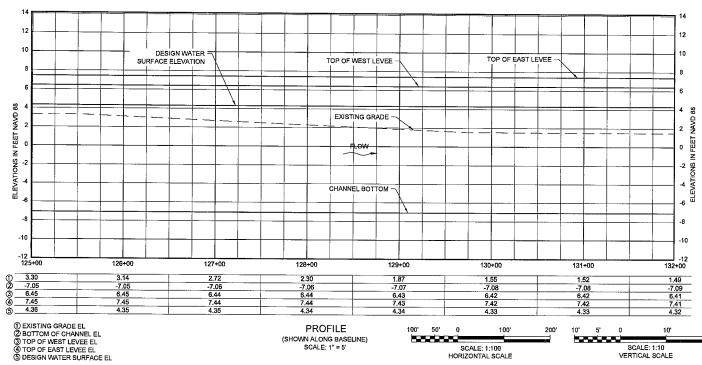
PLAN AND PROFILE

DRAWN BY: APO

DESIGNED BY: CL

SHEET NO.



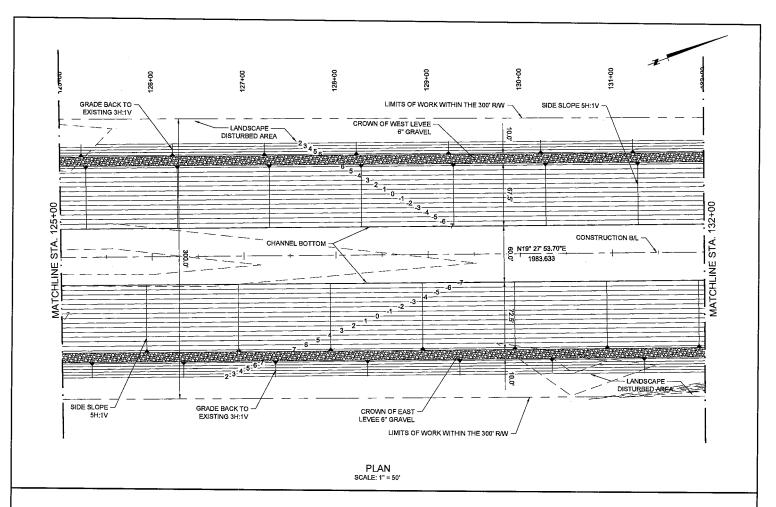

COASTAL PROTECTION AND RESTORATION AUTHORITY 450 LAUREL STREET BATON ROUGE, LOUISIANA 70801

(SHOWN ALONG BASELINE) SCALE: 1" = 5'

RIVER REINTRODUCTION INTO MAUREPAS SWAMP ST. JOHN THE BAPTIST PARISH, LOUISIANA

SCALE: 1:10 VERTICAL SCALE


20'

PROJECT NUMBER: 10001877

PLAN AND PROFILE

DRAWN BY: APO DESIGNED BY: CL SHEET NO.

SCALE: 1:100 HORIZONTAL SCALE

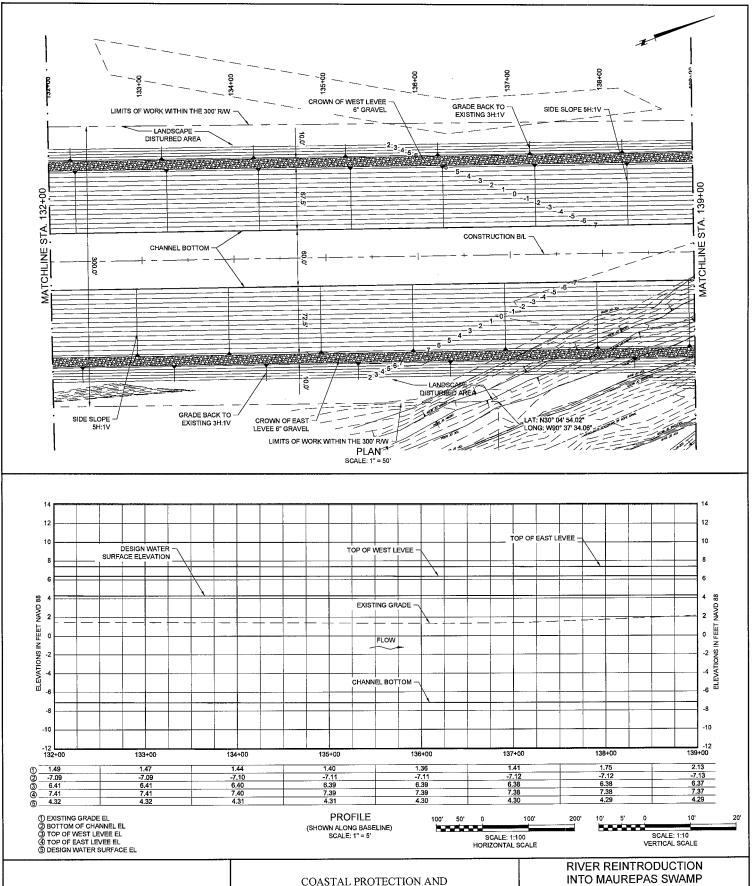

RESTORATION AUTHORITY 450 LAUREL STREET BATON ROUGE, LOUISIANA 70801

INTO MAUREPAS SWAMP ST. JOHN THE BAPTIST PARISH, LOUISIANA


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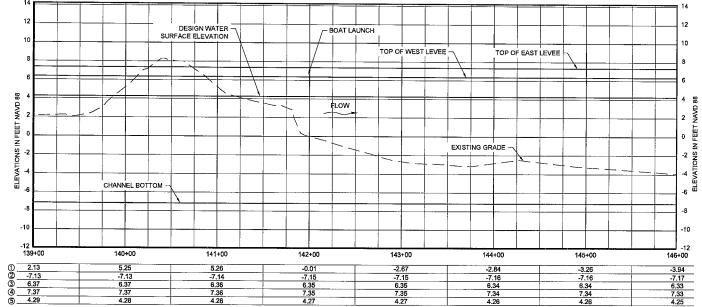
PLAN AND PROFILE

DRAWN BY: APO

DESIGNED BY: CL

SHEET NO.



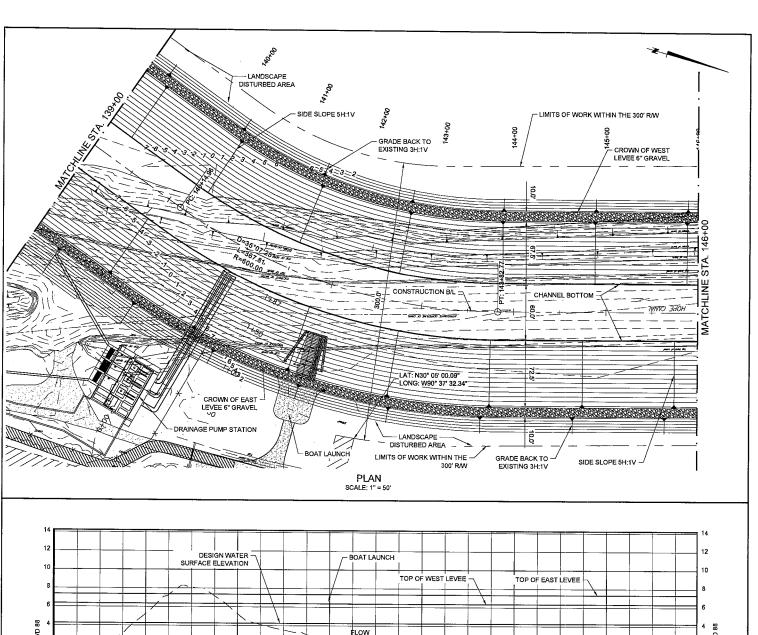

PROFILE (SHOWN ALONG BASELINE) SCALE: 1" = 5' 190' 50' 0 100' 200' SCALE: 1:100 HORIZONTAL SCALE 10' 5' 0 10' 20

SCALE: 1:10

VERTICAL SCALE




3500 N. Causeway Blvd., Suite 900 Metairie, Louisiana 70002 (504) 837-6326 COASTAL PROTECTION AND RESTORATION AUTHORITY 450 LAUREL STREET BATON ROUGE, LOUISIANA 70801 RIVER REINTRODUCTION INTO MAUREPAS SWAMP ST. JOHN THE BAPTIST PARISH, LOUISIANA

PROJECT NUMBER: 10001877

PLAN AND PROFILE

DRAWN BY: APO DESIGNED BY: CL

SHEET NO.

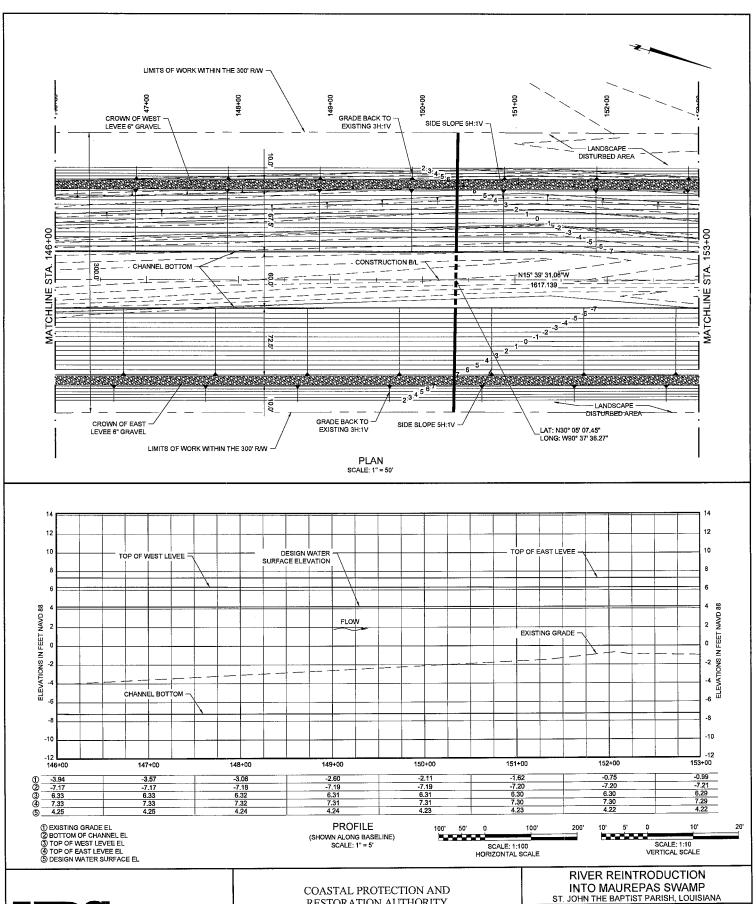




RESTORATION AUTHORITY 450 LAUREL STREET


BATON ROUGE, LOUISIANA 70801

PROJECT NUMBER: 10001877

PLAN AND PROFILE

DESIGNED BY: CL DRAWN BY: APO

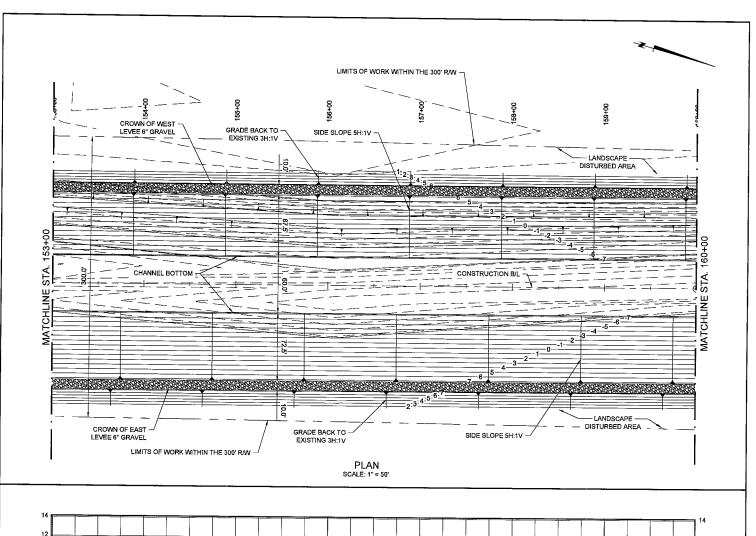

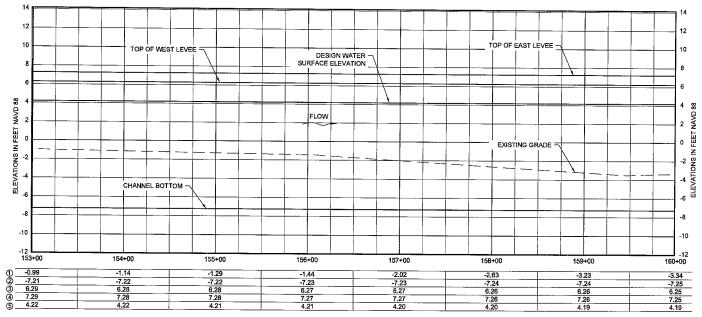

PROFILE (SHOWN ALONG BASELINE) SCALE: 1" = 5' 100' 50' 0 100' 2

SCALE: 1:100

HORIZONTAL SCALE

10' 5' 0 10' 20

SCALE: 1:10

VERTICAL SCALE



3500 N. Causeway Blvd., Suite 900 Metairie, Louisiana 70002 (504) 837-6326 COASTAL PROTECTION AND RESTORATION AUTHORITY 450 LAUREL STREET BATON ROUGE, LOUISIANA 70801 RIVER REINTRODUCTION INTO MAUREPAS SWAMP ST. JOHN THE BAPTIST PARISH, LOUISIANA


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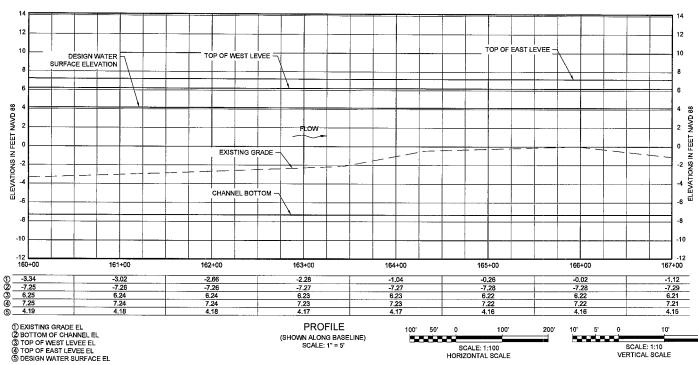
PLAN AND PROFILE

DRAWN BY: APO

DESIGNED BY: CL

SHEET NO.



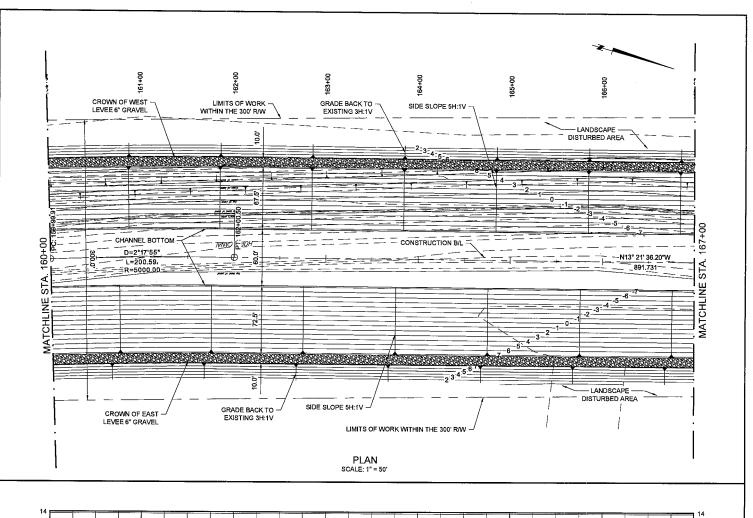

COASTAL PROTECTION AND RESTORATION AUTHORITY 450 LAUREL STREET BATON ROUGE, LOUISIANA 70801

(SHOWN ALONG BASELINE)

SCALE: 1" = 5

RIVER REINTRODUCTION INTO MAUREPAS SWAMP ST. JOHN THE BAPTIST PARISH, LOUISIANA

SCALE: 1:10 VERTICAL SCALE


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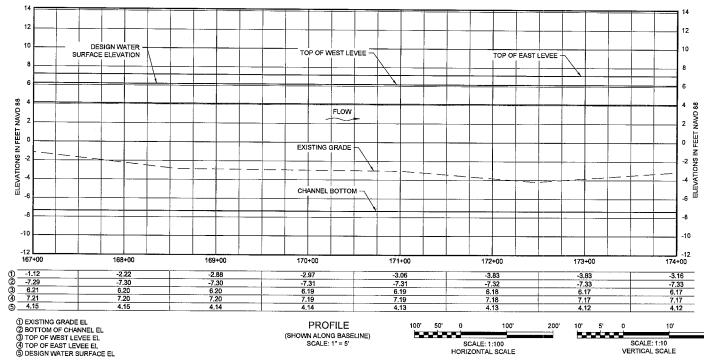
PLAN AND PROFILE

DRAWN BY: APO DESIGNED BY: CL SHEET NO. CC-5.19

SCALE: 1:100

HORIZONTAL SCALE



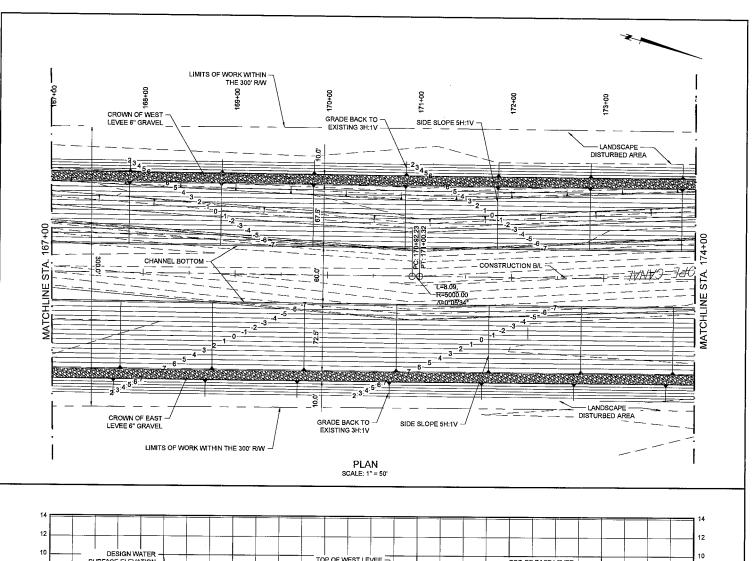

(SHOWN ALONG BASELINE) SCALE: 1" = 5'

200 SCALE: 1:100 HORIZONTAL SCALE

SCALE; 1:10 VERTICAL SCALE

3500 N. Causeway Blvd., Suite 900 Metairie, Louisiana 70002 (504) 837-6326

COASTAL PROTECTION AND RESTORATION AUTHORITY 450 LAUREL STREET BATON ROUGE, LOUISIANA 70801

RIVER REINTRODUCTION INTO MAUREPAS SWAMP ST. JOHN THE BAPTIST PARISH, LOUISIANA


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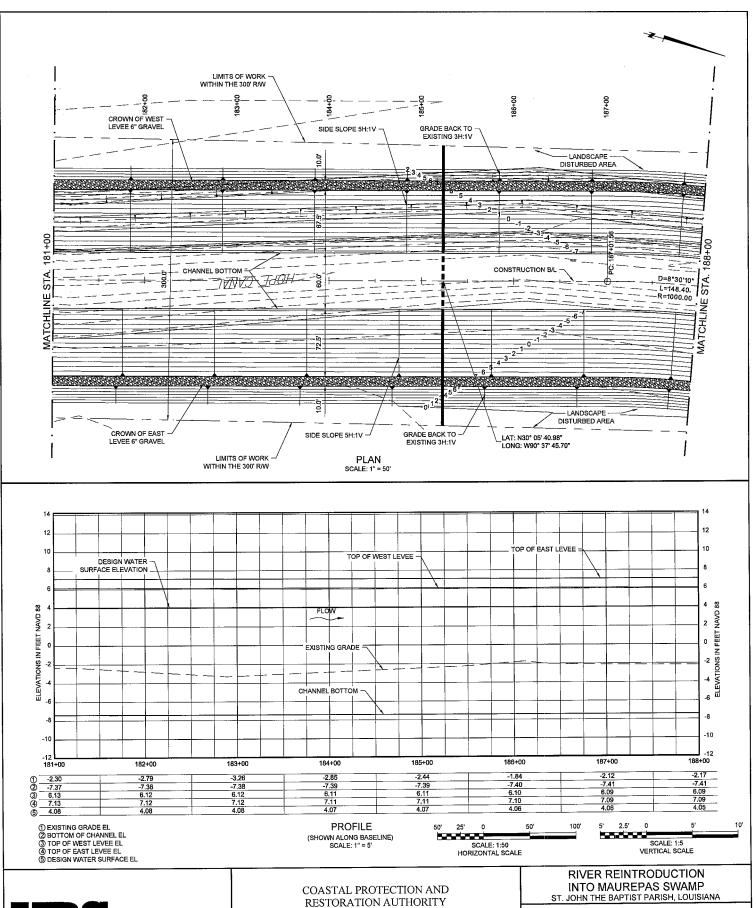
PLAN AND PROFILE

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DESIGNED BY: CL

SHEET NO.



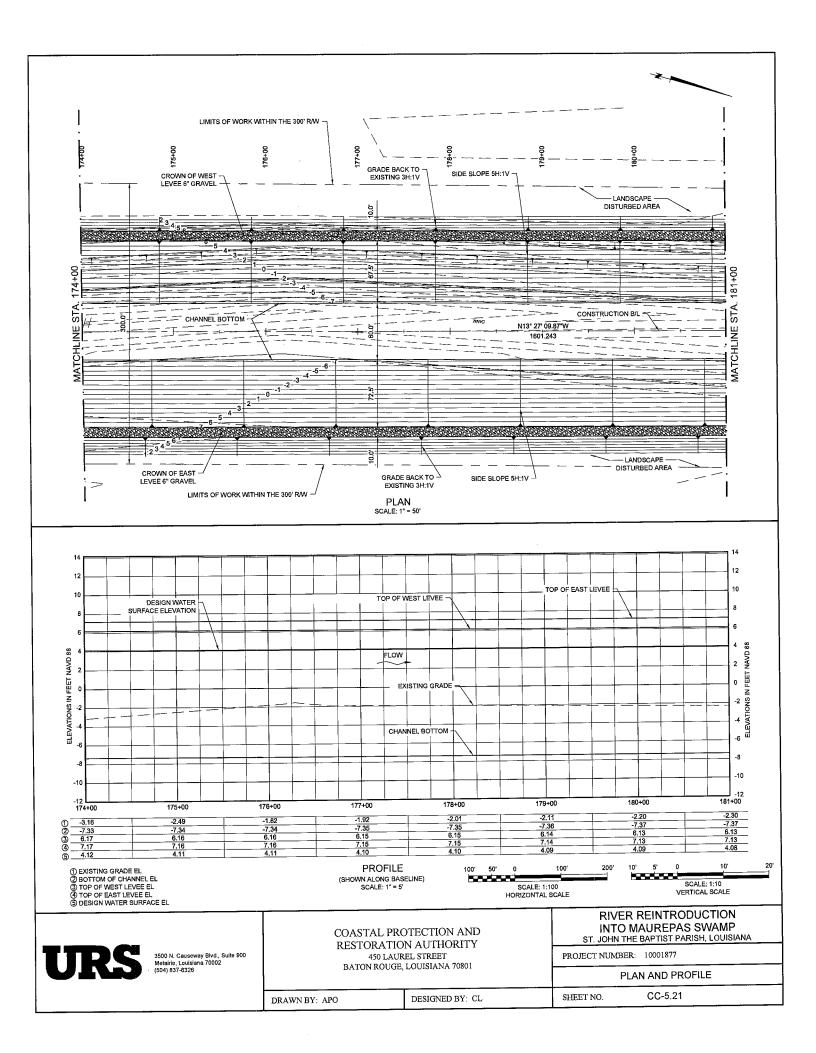


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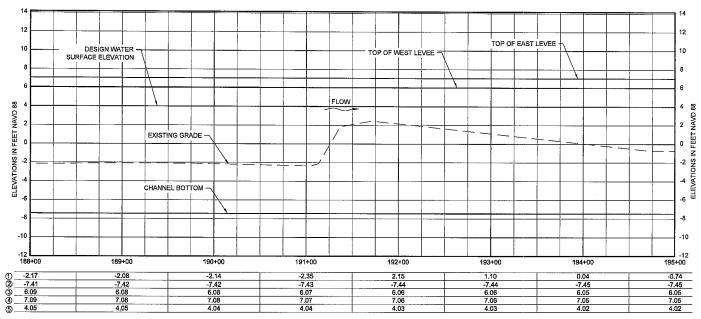
PROJECT NUMBER: 10001877

PLAN AND PROFILE

DRAWN BY: APO DESIGNED BY: CL

SHEET NO.



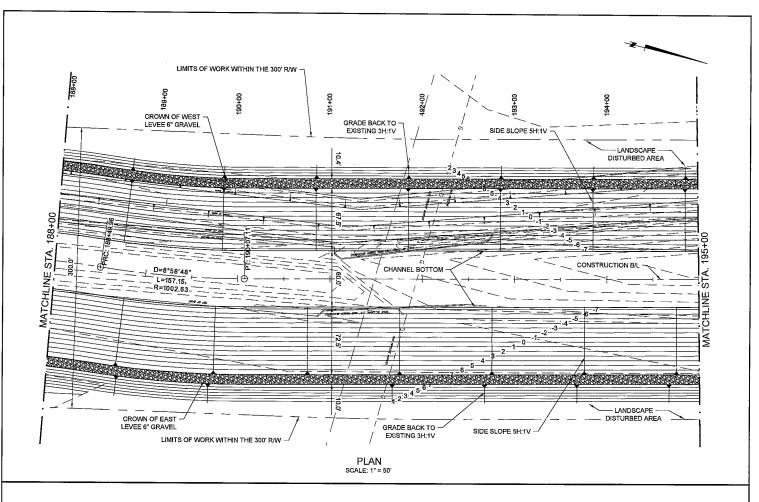

PROFILE (SHOWN ALONG BASELINE) SCALE: 1" = 5' 100' 50' 0 100' 20

SCALE: 1:100

HORIZONTAL SCALE

10' 5' 0 10' 2

SCALE: 1:10

VERTICAL SCALE



3500 N. Causeway Blvd., Suite 900 Metairie, Louisiana 70002 (504) 837-6326 COASTAL PROTECTION AND RESTORATION AUTHORITY 450 LAUREL STREET BATON ROUGE, LOUISIANA 70801 RIVER REINTRODUCTION INTO MAUREPAS SWAMP ST. JOHN THE BAPTIST PARISH, LOUISIANA


PROJECT NUMBER: 10001877

PLAN AND PROFILE

DRAWN BY: APO

DESIGNED BY: CL

SHEET NO.

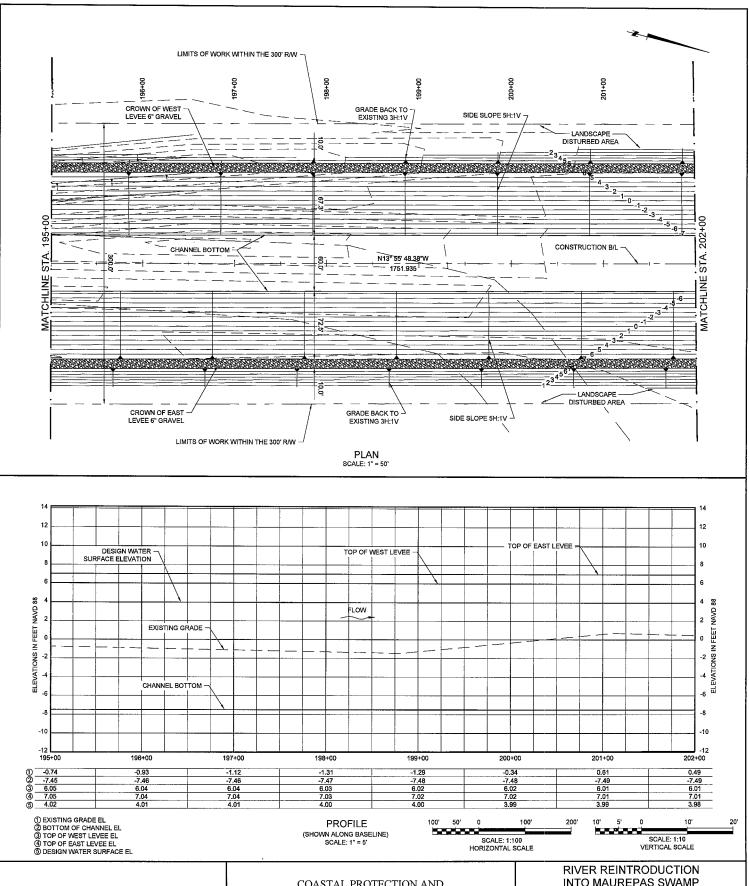

DRAWN BY: APO

COASTAL PROTECTION AND RESTORATION AUTHORITY 450 LAUREL STREET BATON ROUGE, LOUISIANA 70801


INTO MAUREPAS SWAMP ST. JOHN THE BAPTIST PARISH, LOUISIANA


PROJECT NUMBER: 10001877

PLAN AND PROFILE

DESIGNED BY: CL

SHEET NO.

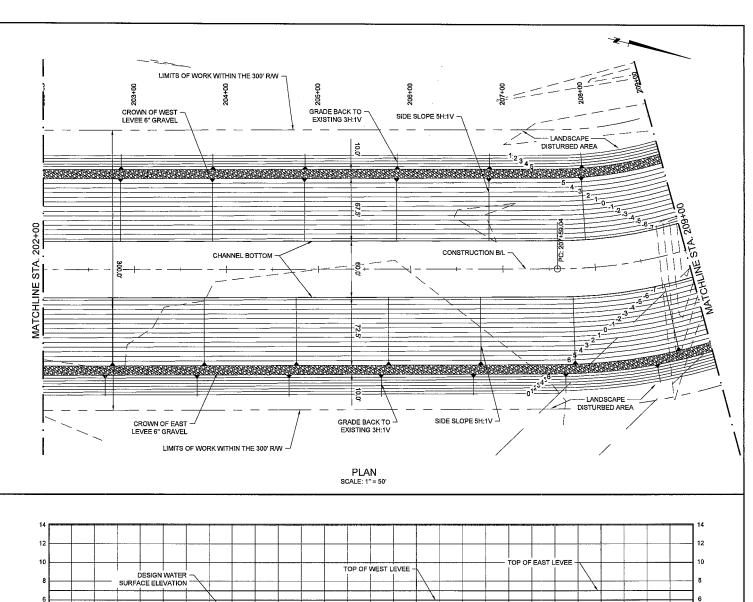

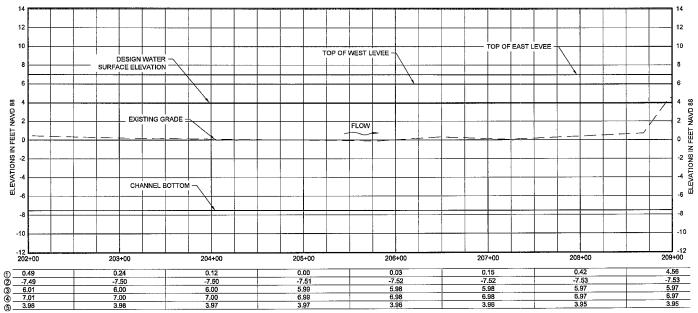

PROFILE (SHOWN ALONG BASELINE) SCALE: 1" = 5' 100' 50' 0 100' 200'

SCALE: 1:100

HORIZONTAL SCALE

10' 5' 0 10' 2'

SCALE: 1:10

VERTICAL SCALE



3500 N. Causeway Blvd., Suite 900 Metairie, Louisiana 70002 (504) 837-6326 COASTAL PROTECTION AND RESTORATION AUTHORITY 450 LAUREL STREET BATON ROUGE, LOUISIANA 70801 RIVER REINTRODUCTION INTO MAUREPAS SWAMP ST. JOHN THE BAPTIST PARISH, LOUISIANA


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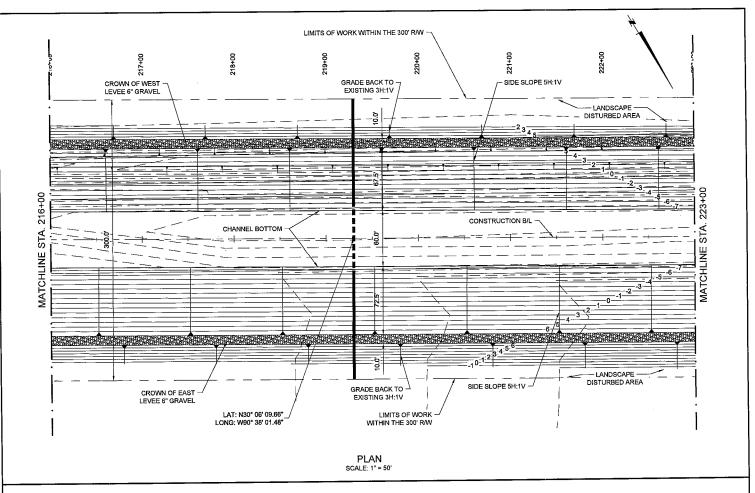
PLAN AND PROFILE


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DESIGNED BY: CL

SHEET NO.





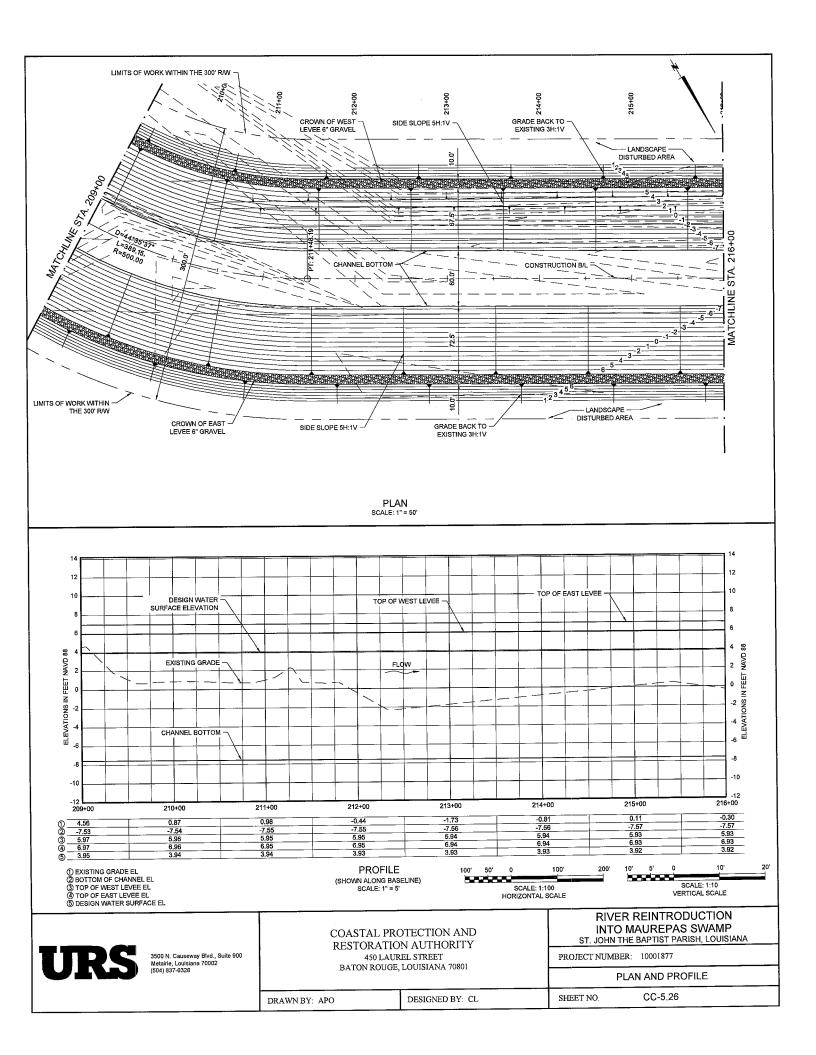

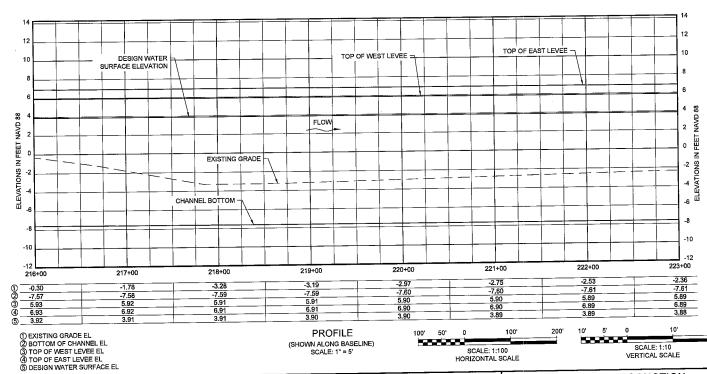COASTAL PROTECTION AND RESTORATION AUTHORITY 450 LAUREL STREET BATON ROUGE, LOUISIANA 70801


RIVER REINTRODUCTION INTO MAUREPAS SWAMP ST. JOHN THE BAPTIST PARISH, LOUISIANA


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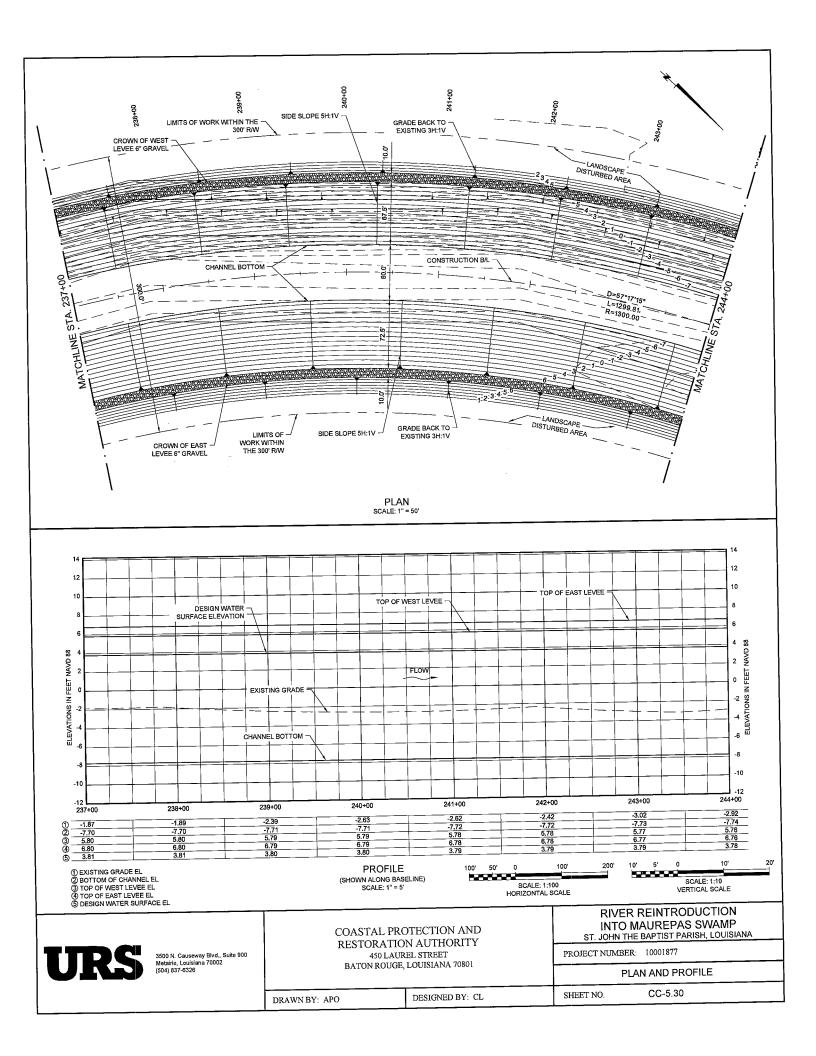
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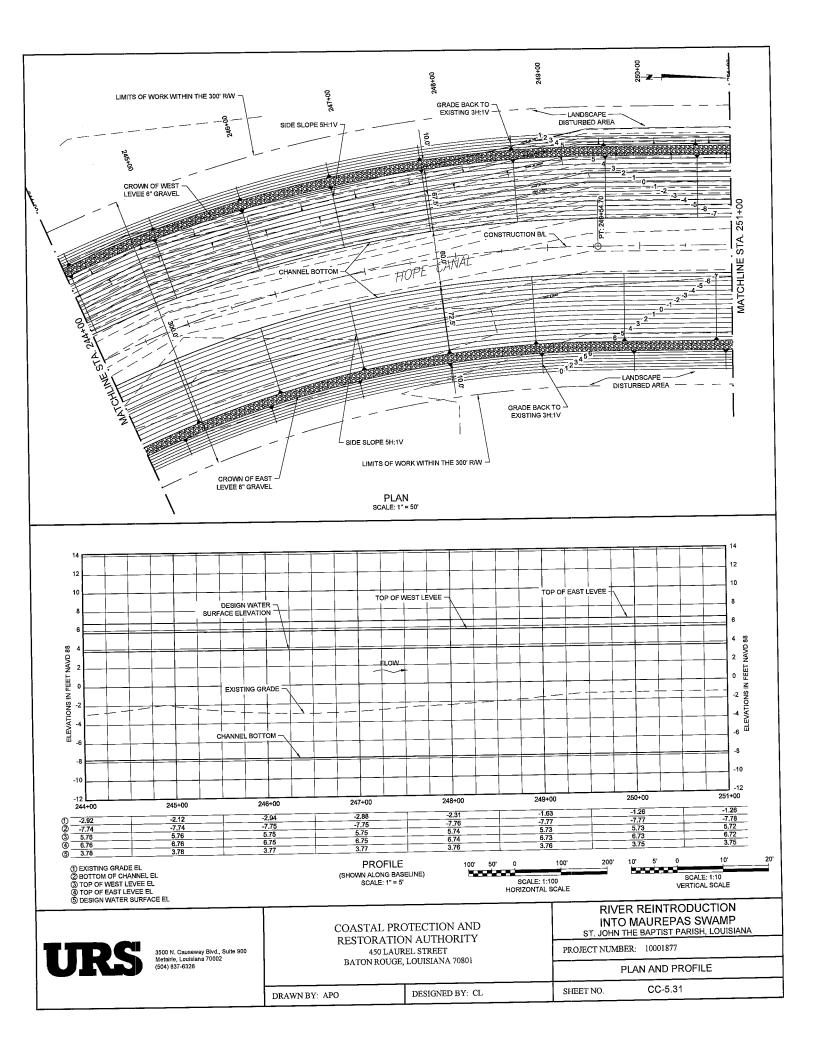
PLAN AND PROFILE CC-5.27


DESIGNED BY: CL DRAWN BY: APO





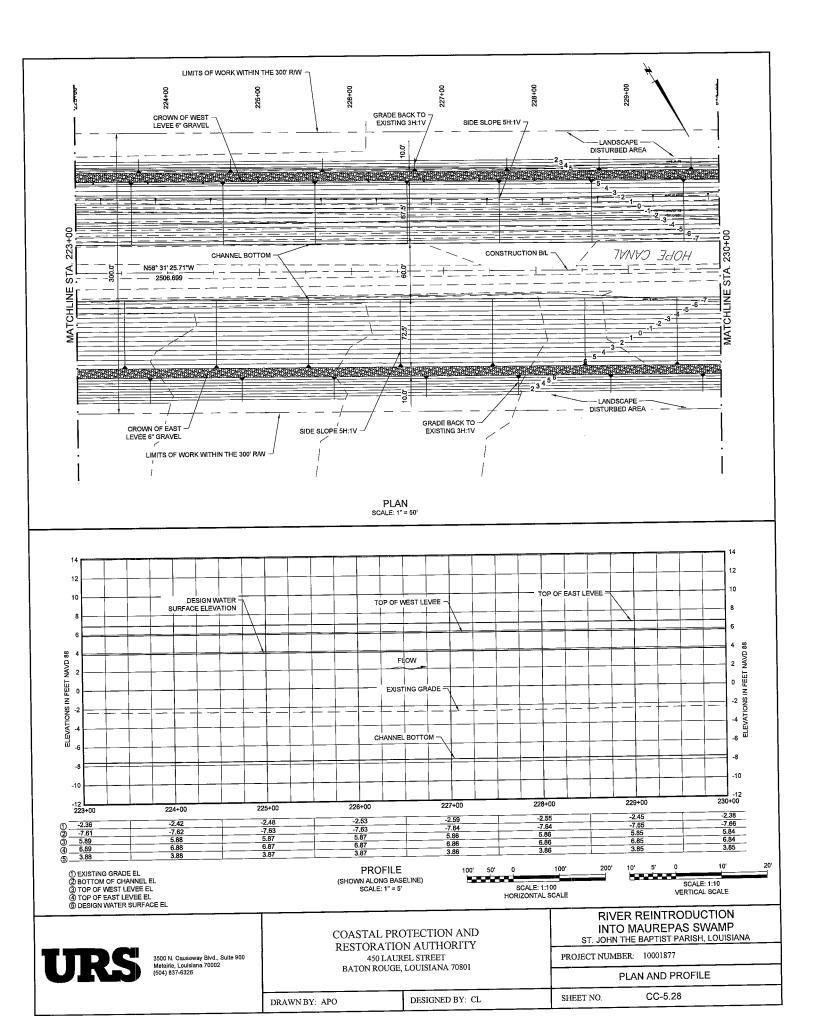

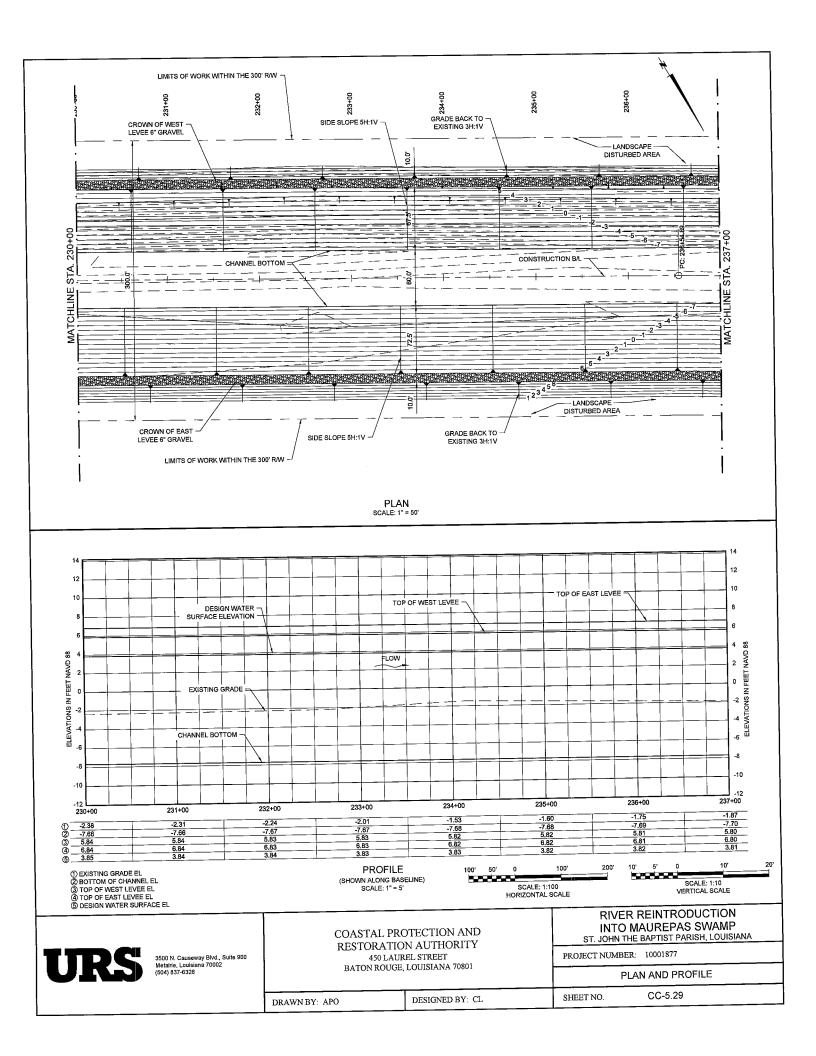

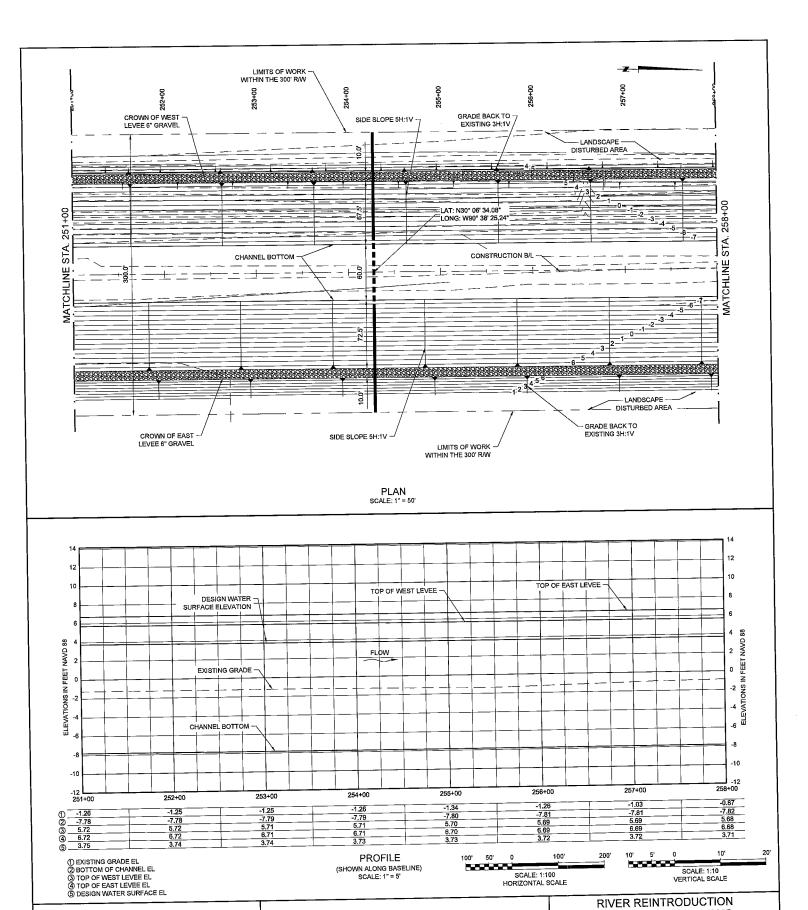



COASTAL PROTECTION AND RESTORATION AUTHORITY 450 LAUREL STREET BATON ROUGE, LOUISIANA 70801

INTO MAUREPAS SWAMP ST. JOHN THE BAPTIST PARISH, LOUISIANA

PROJECT NUMBER: 10001877


PLAN AND PROFILE


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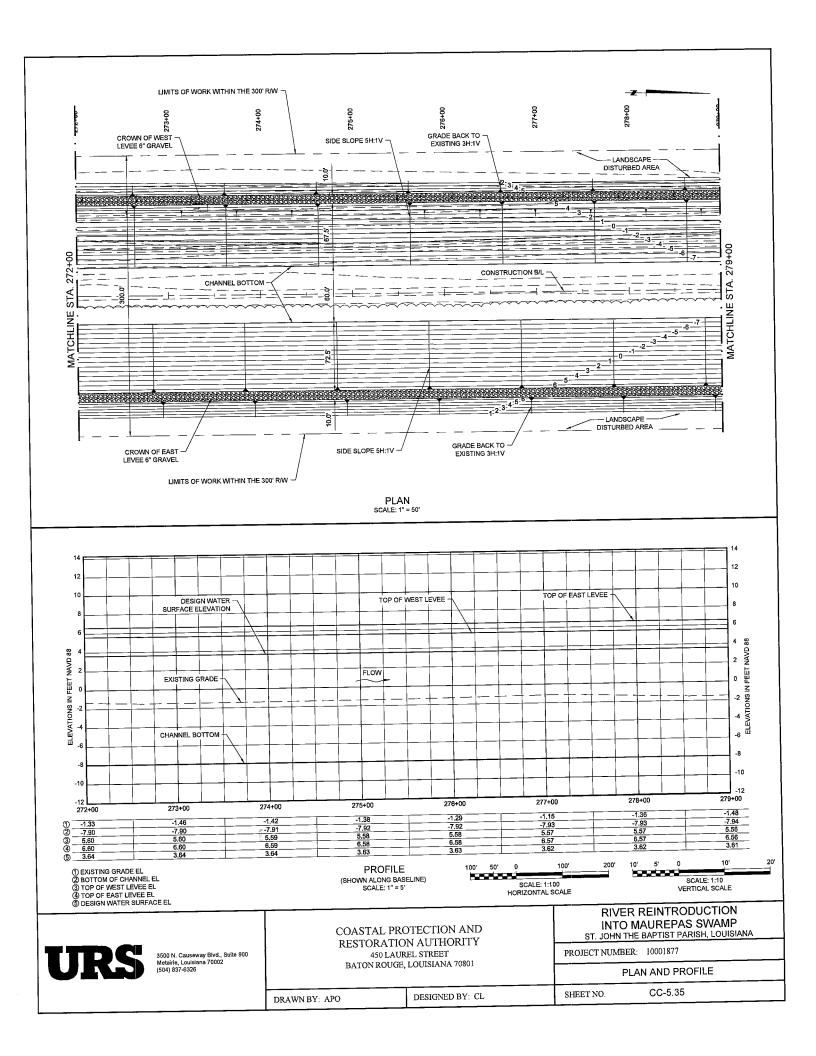
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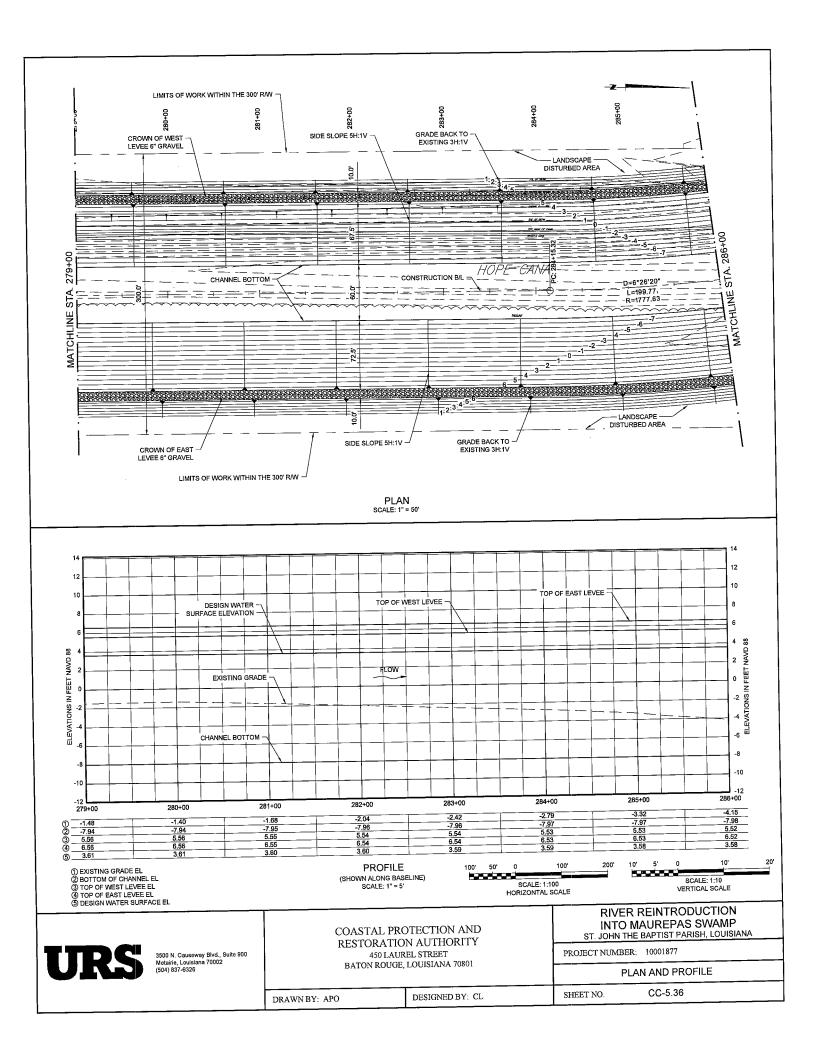
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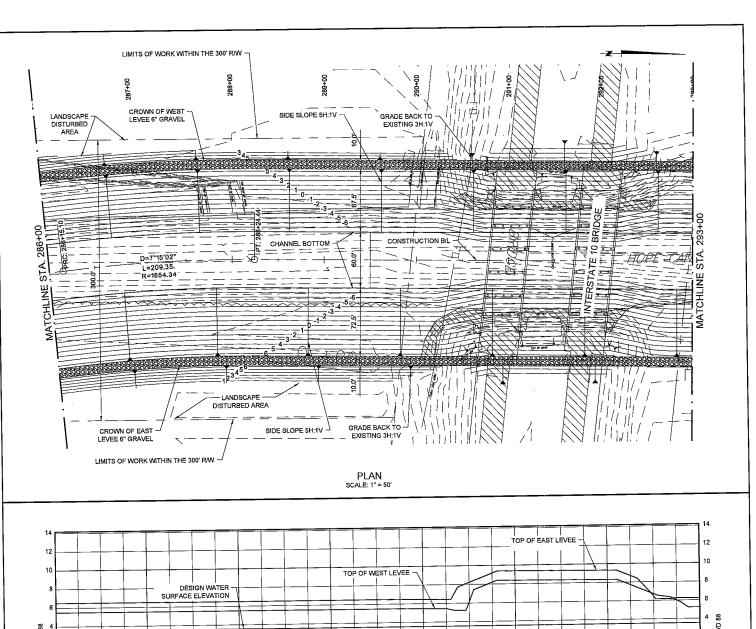
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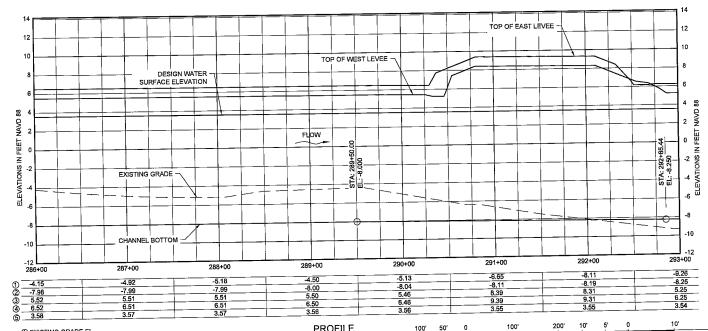








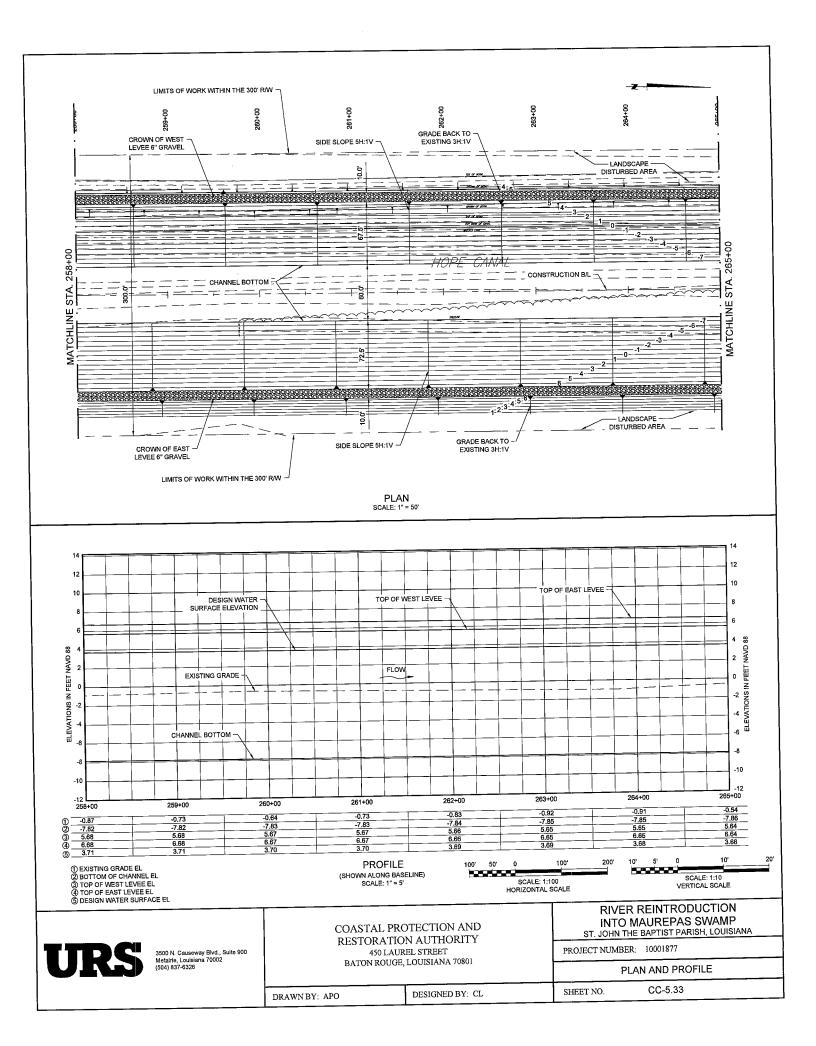

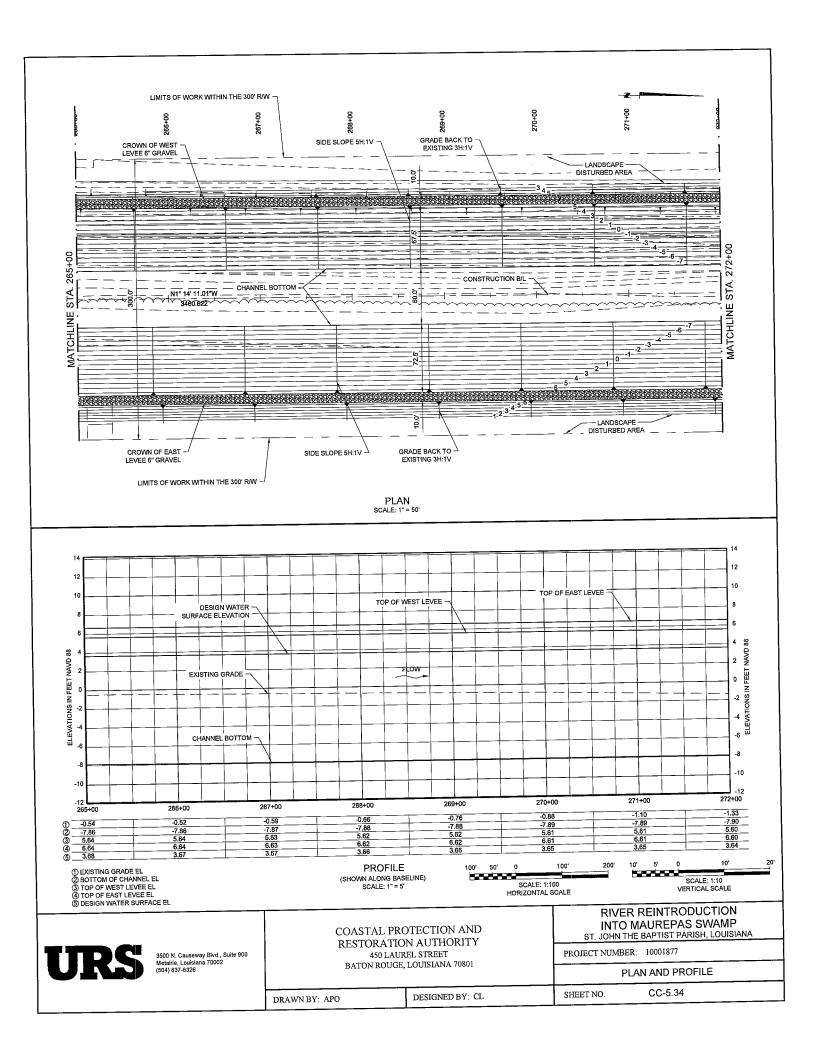

PROFILE (SHOWN ALONG BASELINE) SCALE: 1" = 5' 100' 50' 0 100'

SCALE: 1:100

HORIZONTAL SCALE

10' 5' 0 10'

SCALE: 1:10

VERTICAL SCALE



3500 N. Causeway Blvd., Suite 900 Metairie, Louisiana 70002 (504) 837-6326 COASTAL PROTECTION AND RESTORATION AUTHORITY 450 LAUREL STREET BATON ROUGE, LOUISIANA 70801

ST. JOHN THE BAPTIST PARISH, LOUISIANA
PROJECT NUMBER: 10001877


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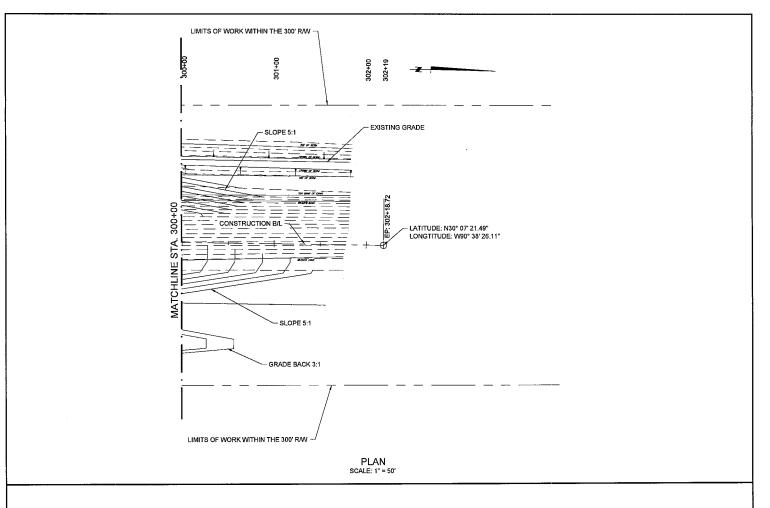
RIVER REINTRODUCTION INTO MAUREPAS SWAMP


DRAWN BY: APO

DESIGNED BY: CL

SHEET NO.



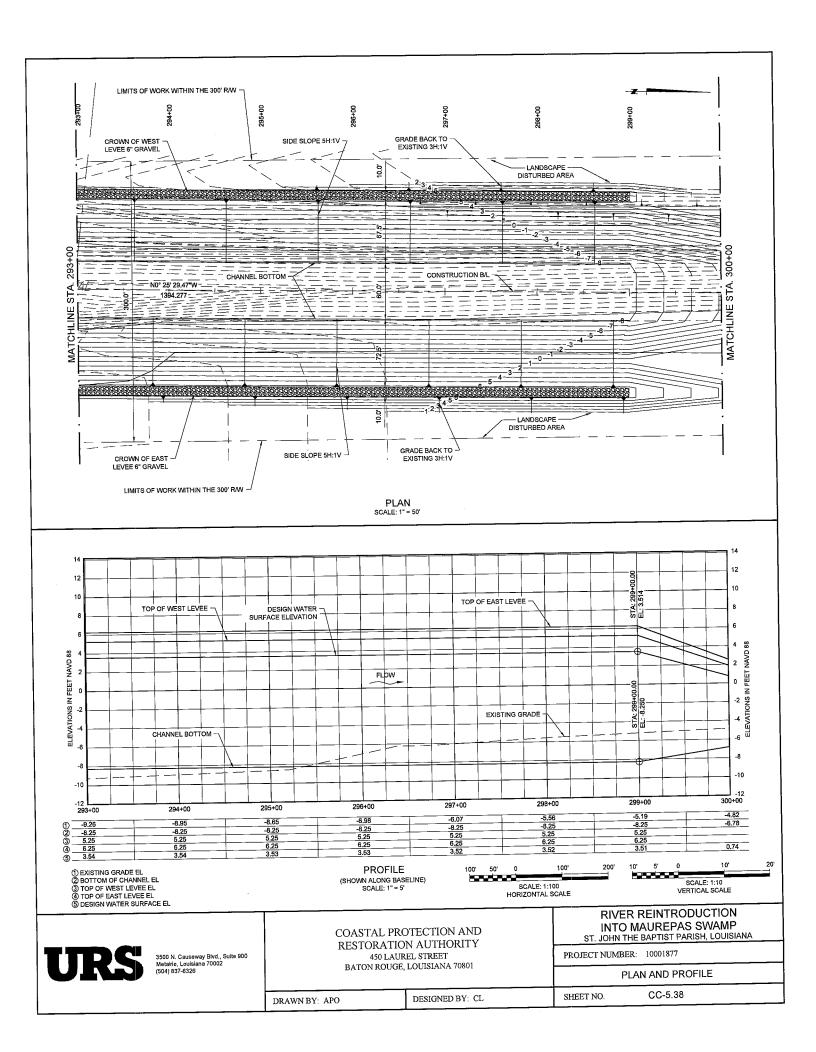

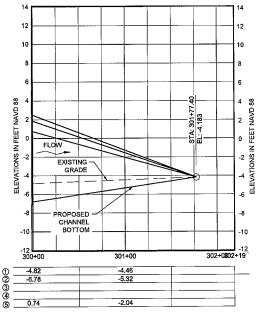

PROFILE (SHOWN ALONG BASELINE) SCALE: 1" = 5' 100' 50' 0 100' 200' SCALE: 1:100 HORIZONTAL SCALE





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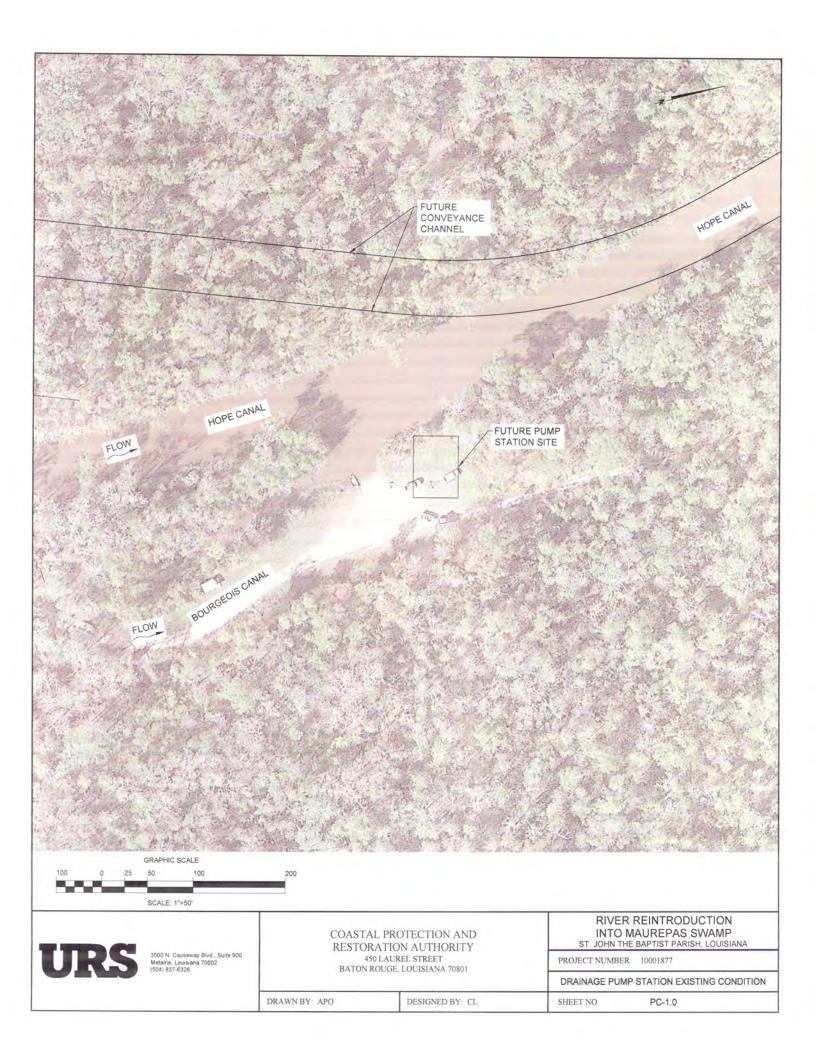
PROJECT NUMBER: 10001877


PLAN AND PROFILE


DRAWN BY: APO

DESIGNED BY: CL

SHEET NO.



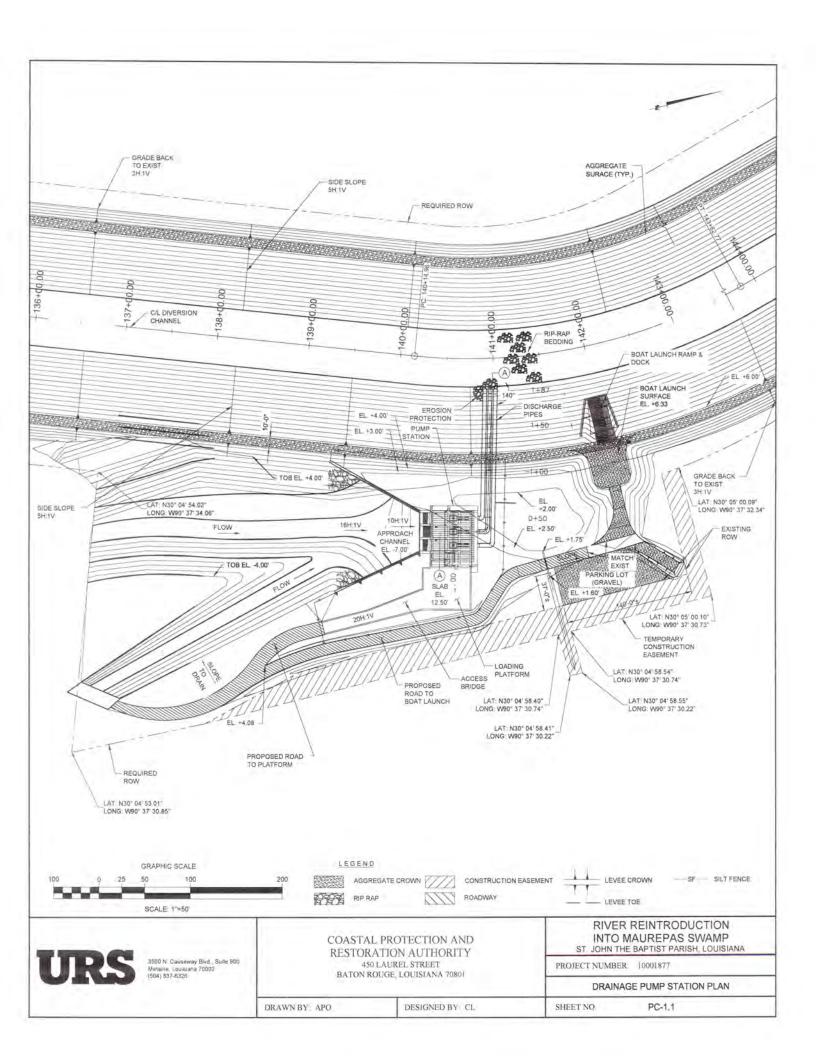

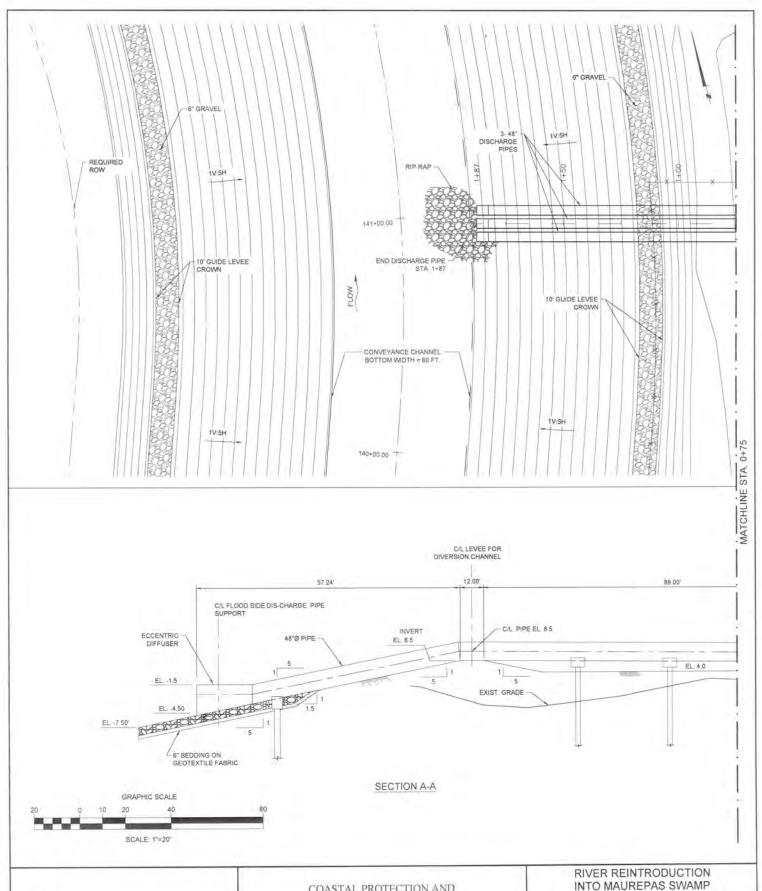

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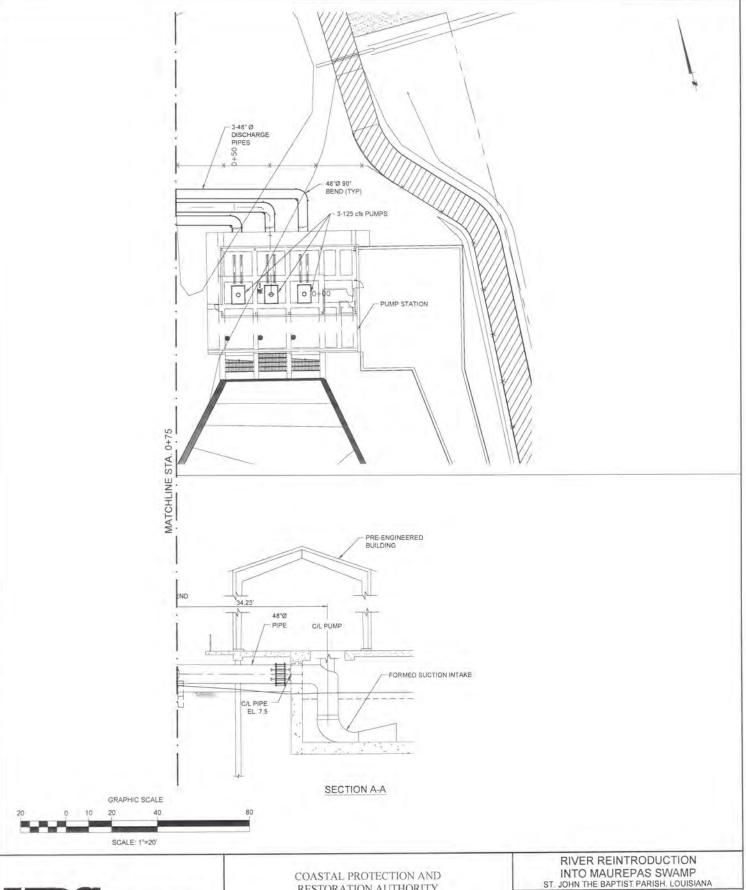
ST. JOHN THE BAPTIST PARISH, LOUISIANA PROJECT NUMBER: 10001877

DRAINAGE PUMP STATION DISCHARGE PIPING PLAN & PROFILE

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DESIGNED BY: CL

SHEET NO PC-1.2



RESTORATION AUTHORITY 450 LAUREL STREET

BATON ROUGE, LOUISIANA 70801


PROJECT NUMBER: 10001877


DRAINAGE PUMP STATION DISCHARGE PIPING PLAN & PROFILE


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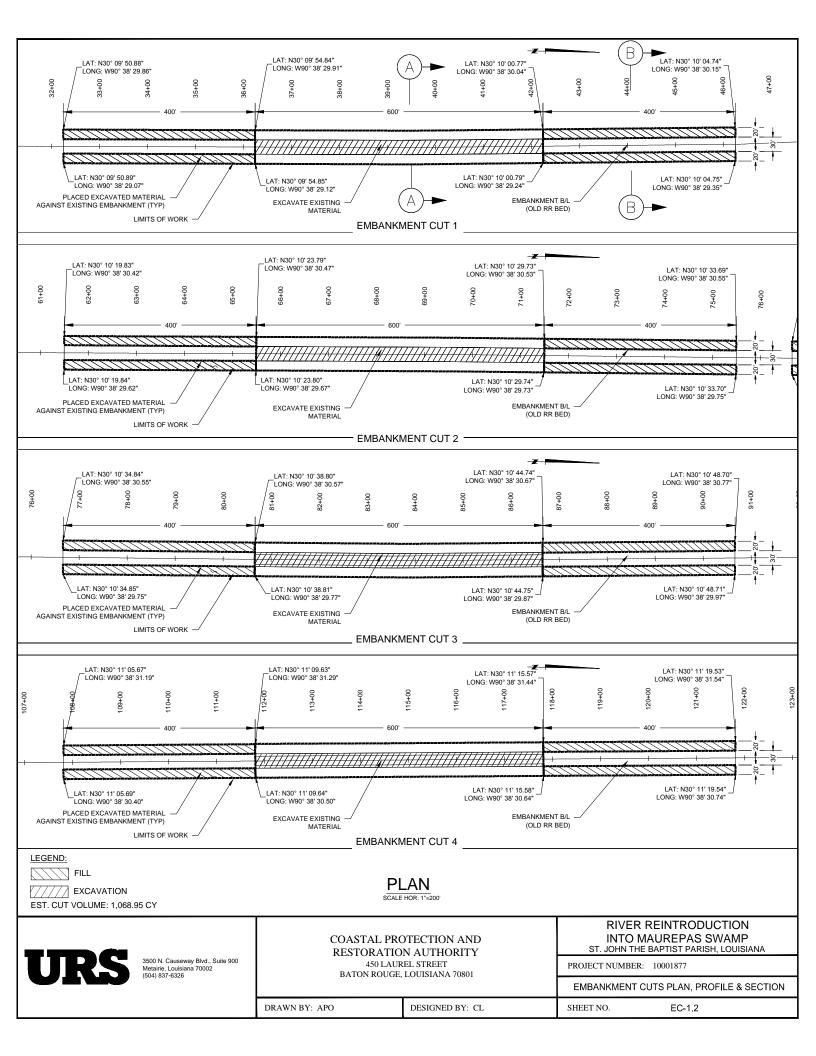
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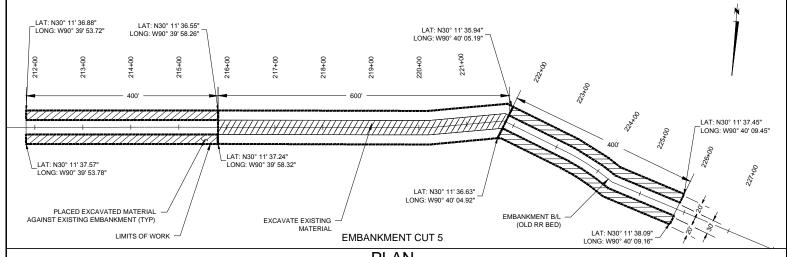
SHEET NO. PC-1.3





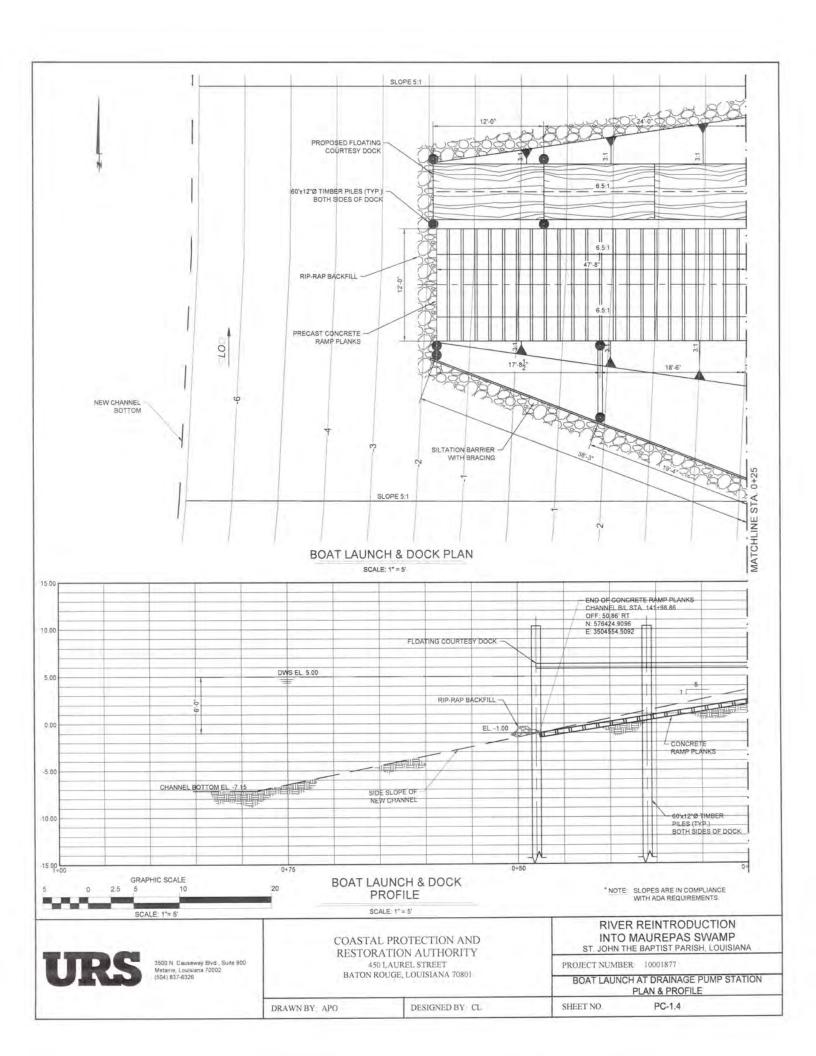


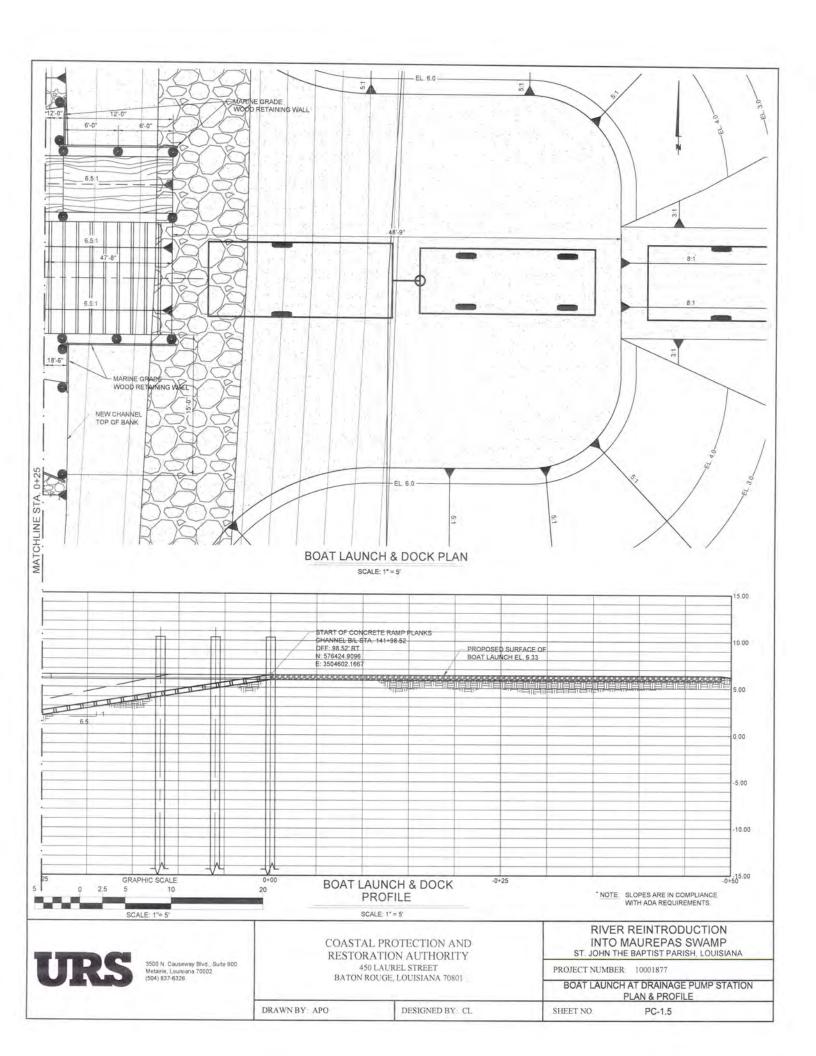

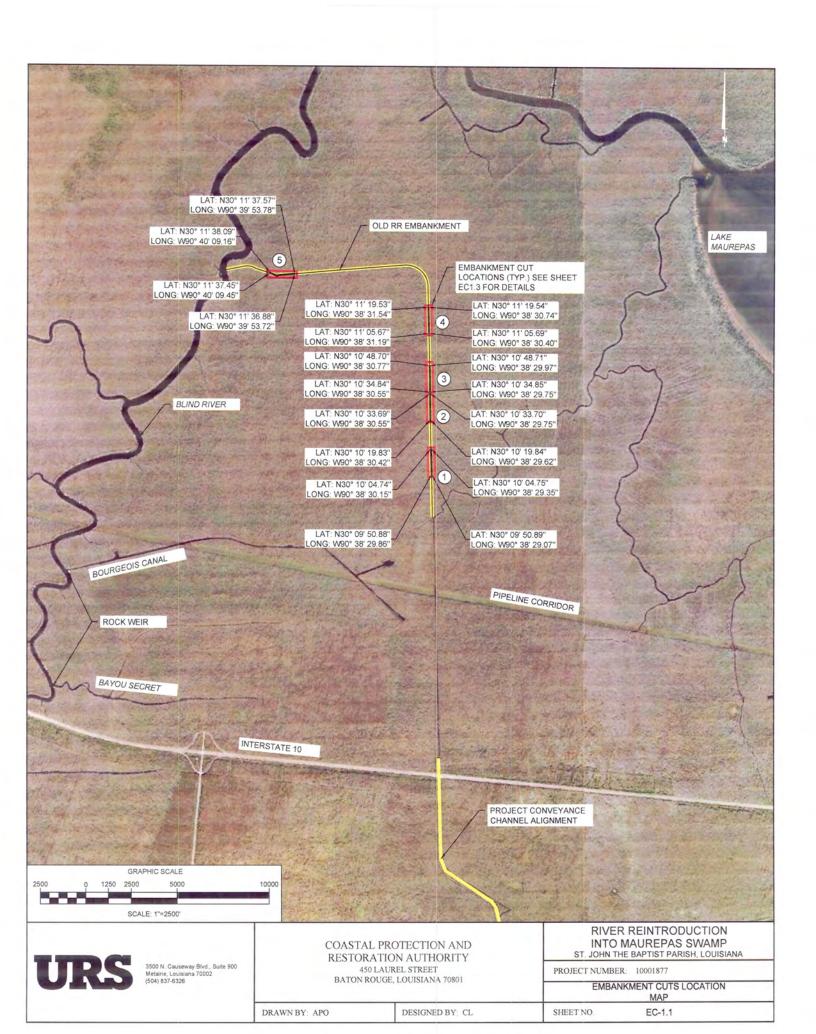

PLAN

SCALE HOR: 1"=200

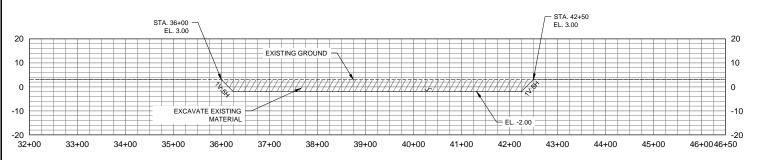

PROFILE SCALE HOR: 1"=100' SCALE VERT: 1"=5'

EXISTING GROUND

5


0

-5

-20

0

39+00.00

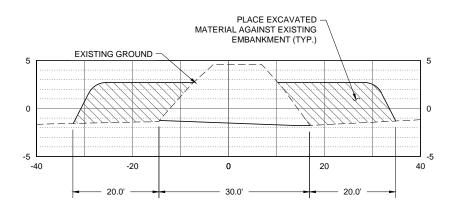

SECTION A-A

SECTION B-B

LEGEND:

FILL

///// EXCAVATION

EST. CUT VOLUME: 1,068.95 CY

NOTE:

DISPOSE OF EXCAVATED MATERIAL ALONG THE EXISTING BERM UP-STATION OF 36+00 AND DOWN-STATION OF 42+50 AS SHOWN ON SHEET EC-1.3, SO THAT THE CUT SECTION PRESENTS AN OPEN PASSAGE-WAY FOR WATER FLOW. (TYPICAL ALL CUTS)




3500 N. Causeway Blvd., Suite 900 Metairie, Louisiana 70002 (504) 837-6326 COASTAL PROTECTION AND RESTORATION AUTHORITY


450 LAUREL STREET BATON ROUGE, LOUISIANA 70801 RIVER REINTRODUCTION
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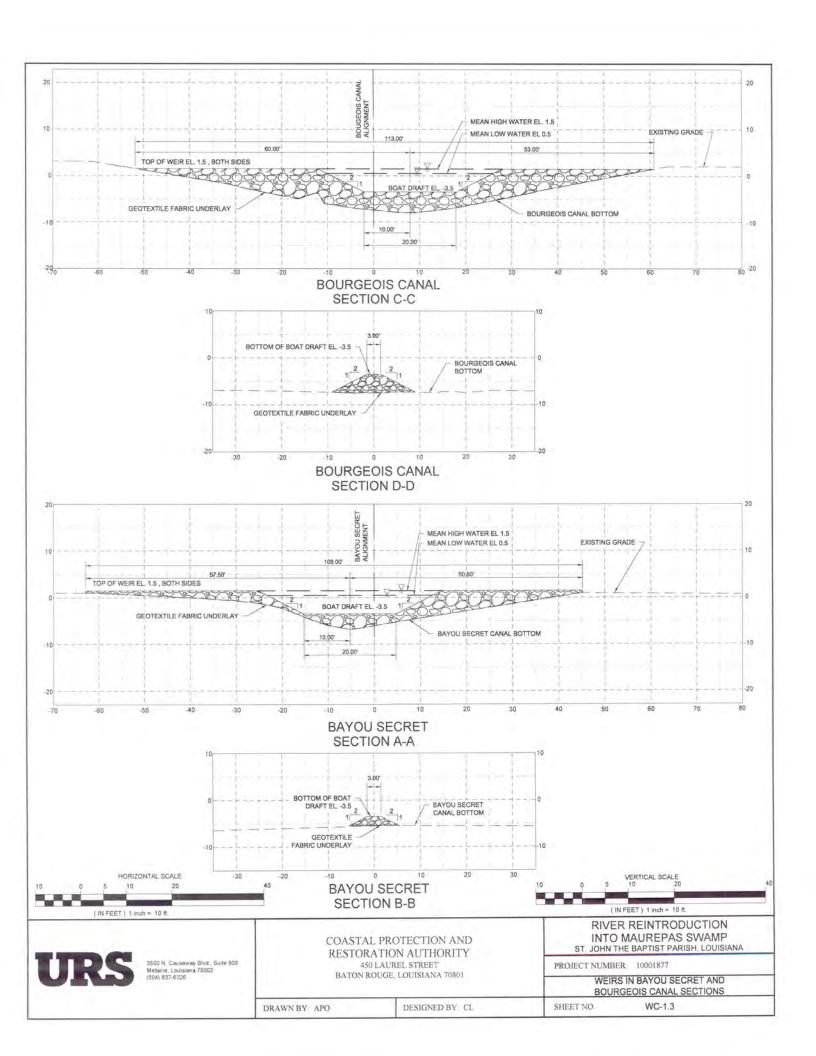
PROJECT NUMBER: 10001877


EMBANKMENT CUTS PLAN, PROFILE & SECTION


DRAWN BY: APO DESIGNED BY: CL SHEET NO. EC-1.3



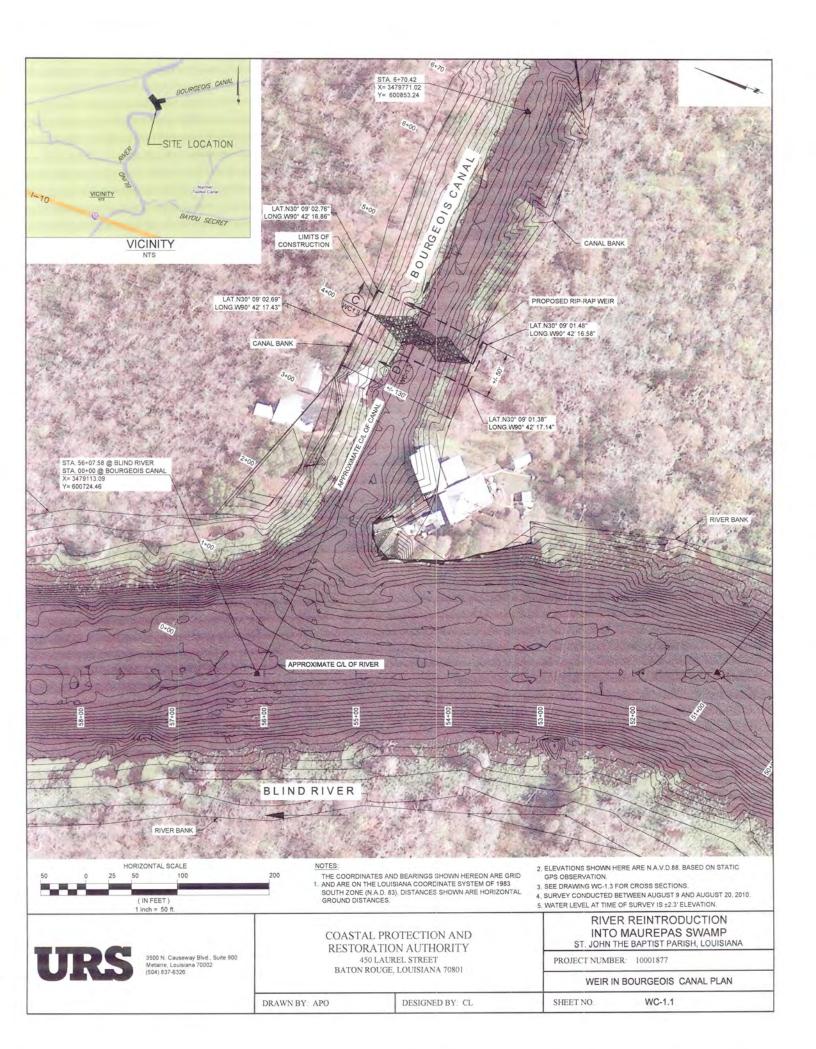

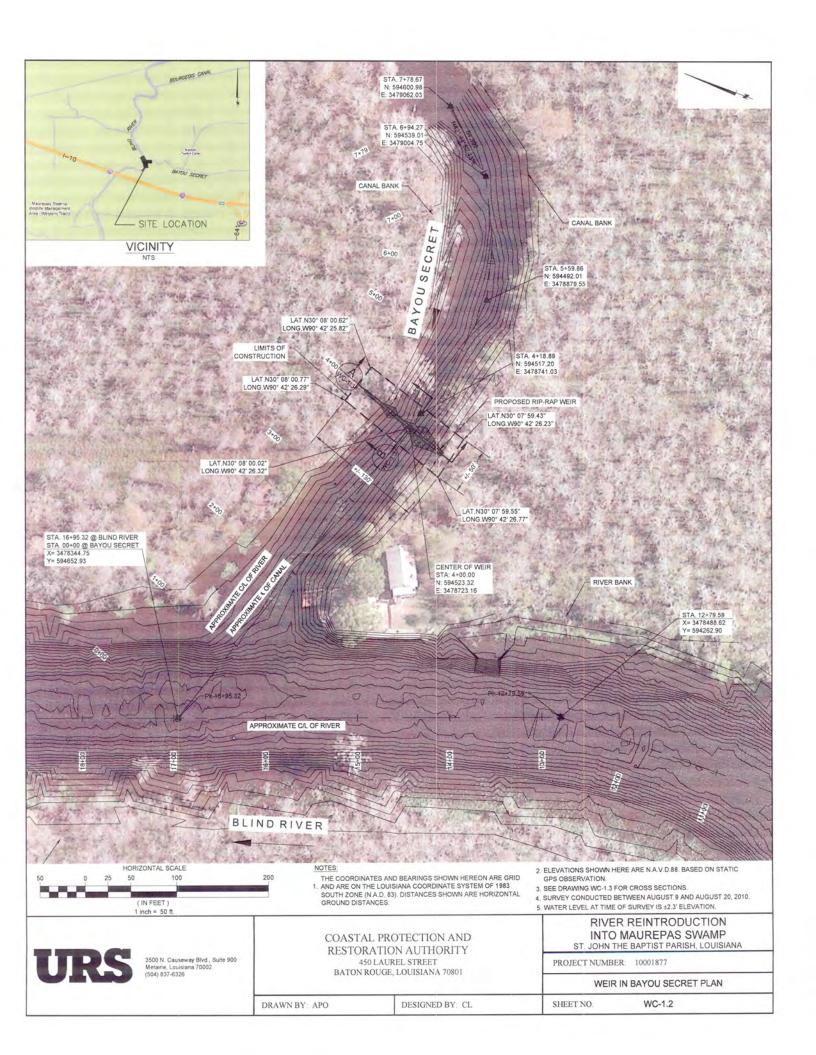

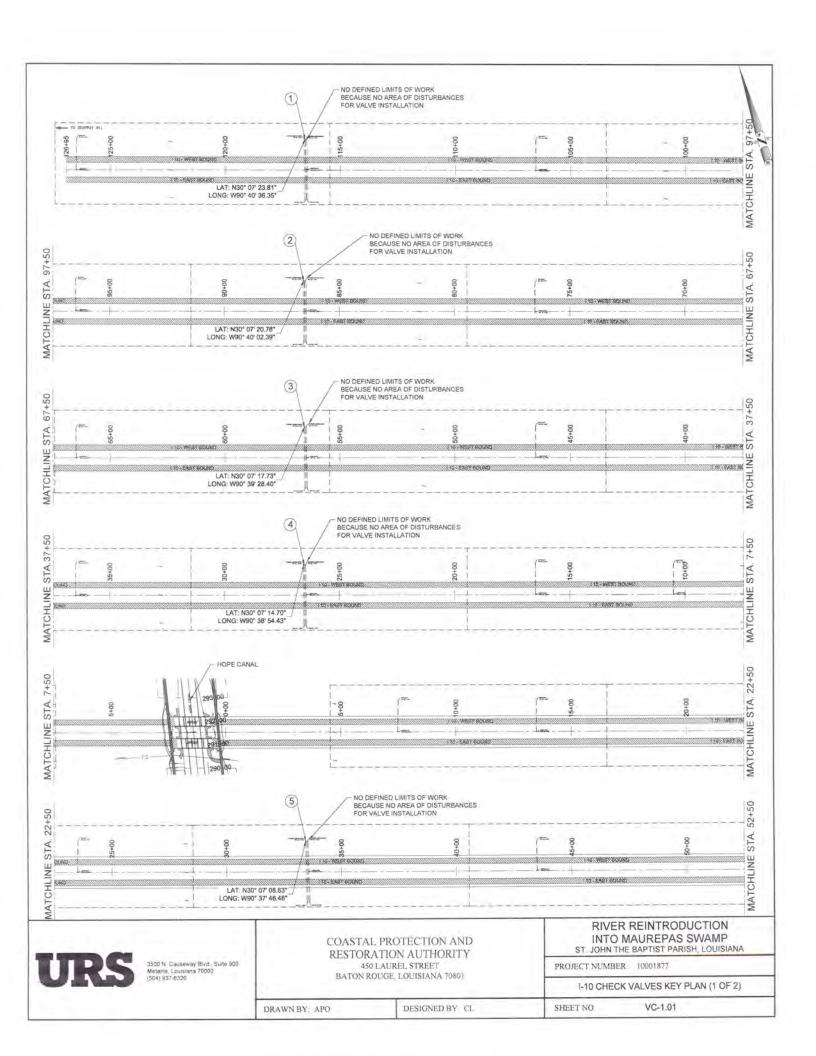

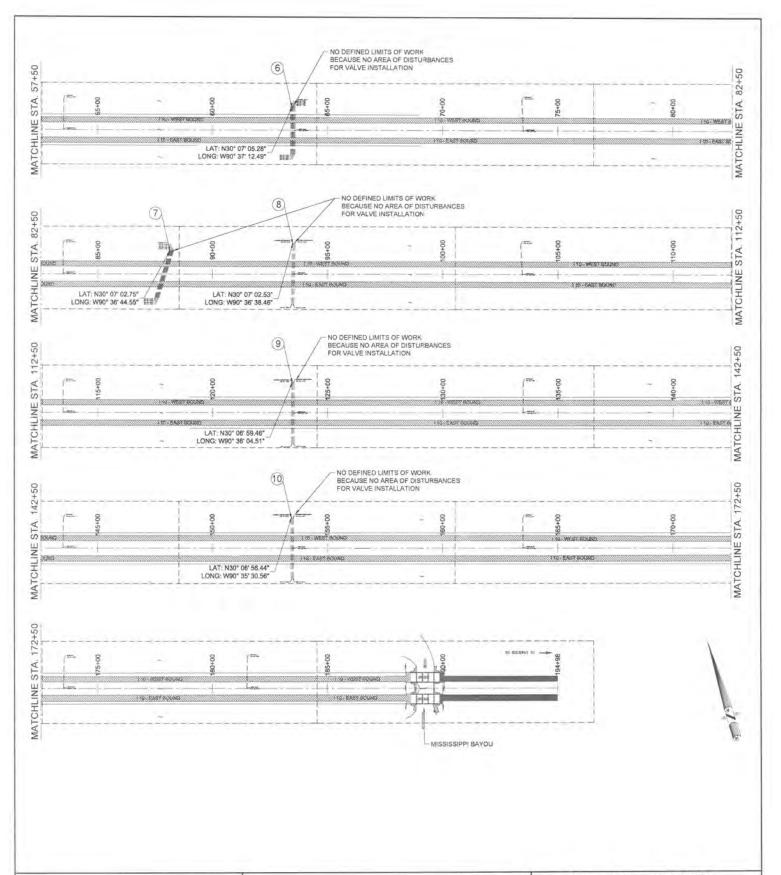



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PROJECT NUMBER 10001877


1-10 CHECK VALVES KEY PLAN (2 OF 2)


DRAWN BY APO

DESIGNED BY CL

SHEET NO.

VC-1.02

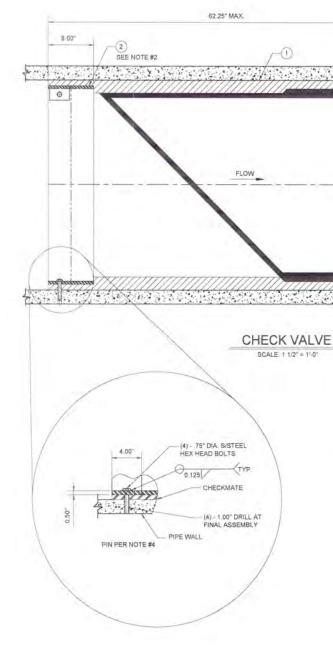

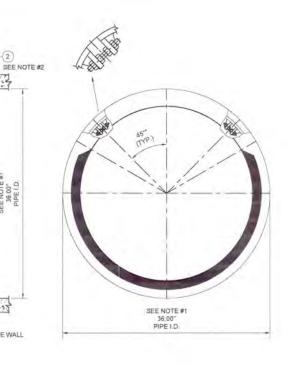

| LOCATION NUMBER | EXISTING PIPE SIZE AND MATERIAL | EXISTING PIPE LOCATION STATION | NO. OF PIPES |
|--------------------|---|--------------------------------|--------------|
| 1 | 36" I.D. CONCRETE | 510+43 | 4 |
| 2 | 36" I.D. CONCRETE | 360+47 | -4 |
| 3 | 55"X44" I.D. CORRUGATED METAL PIPE (CMP) | 330+47 | . 2 |
| 4 | 55"X44" I.D. CORRUGATED METAL PIPE (CMP) | 360+47 | 2 |
| 5 | 55"X44" I.D. CORRUGATED METAL PIPE (CMP) | 390+47 | 2 |
| 6 | 55"X44" I.D. CORRUGATED METAL PIPE (CMP) | 420+47 | .2 |
| 7 | 55"X44" I.D. CORRUGATED METAL PIPE (CMP) | 480+47 | 2 |
| 8 | 55"X44" I.D. CORRUGATED METAL PIPE (CMP) | 540+47 | .2 |
| 9 | 55"X44" I.D. CORRUGATED METAL PIPE (CMP) | 570+47 | 2 |
| 10 | 55"X44" I.D. CORRUGATED METAL PIPE (CMP) | 600+47 | 2 |

NOTES:

- PIPE INSIDE DIAMETER 36 INCH FOR CONCRETE PIPES; 44" X 55" CMP CLAMPS INSTALLED IN UPSTREAM CUFF. MAXIMUM ALLOWABLE BACK PRESSURE 20.0 FEET FOR CONCRETE PIPE, 10 FT FOR CMP IT IS RECOMMENDED TO BOLT OR PIN CHECK VALVE TO PIPE AS SHOWN, 4 PLACES 90" APART.

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COASTAL PROTECTION AND RESTORATION AUTHORITY 450 LAUREL STREET BATON ROUGE, LOUISIANA 70801

8.00

0

SEE NOTE #1 36.00" PIPE I.D.

PIPE WALL

RIVER REINTRODUCTION INTO MAUREPAS SWAMP ST. JOHN THE BAPTIST PARISH, LOUISIANA

PROJECT NUMBER 10001877


I-10 CHECK VALVES DETAILS


DRAWN BY: APO

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SHEET NO

VC-1.03



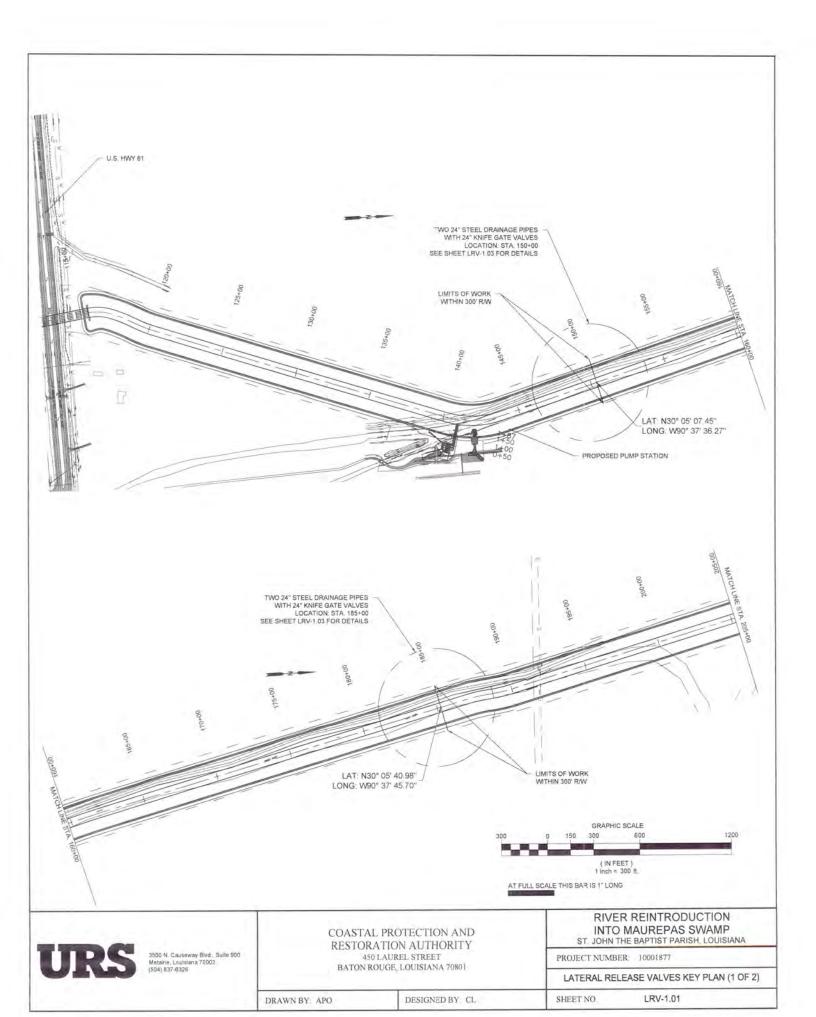
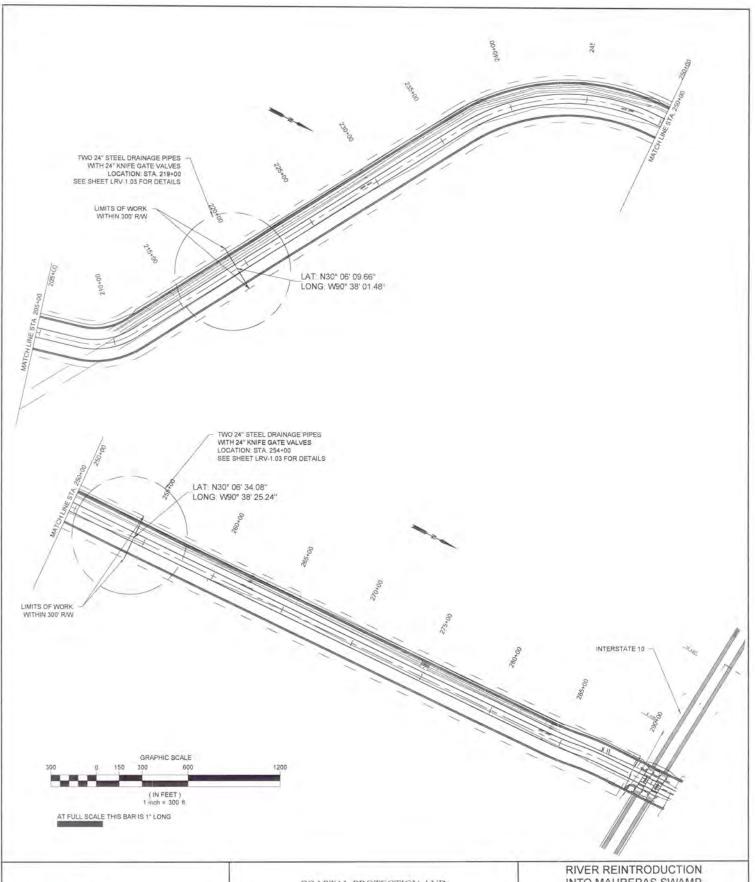
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INTO MAUREPAS SWAMP
ST. JOHN THE BAPTIST PARISH, LOUISIANA

PROJECT NUMBER 10001877


LATERAL RELEASE VALVES KEY PLAN (2 OF 2)


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DESIGNED BY CL


SHEET NO.

LRV-1.02



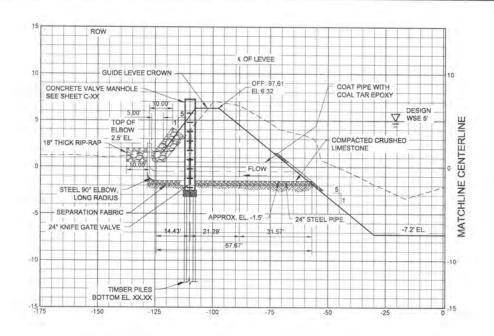

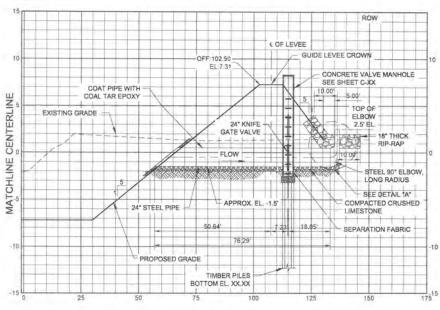LATERAL RELEASE VALVE TYPICAL SECTION

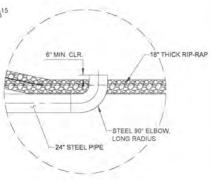

DETAIL "A"



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PROJECT NUMBER: 10001877

LATERAL RELEASE VALVES - DETAILS

DRAWN BY: APO

DESIGNED BY CL

SHEET NO.

LRV - 1.03